





## Schedule of Drawings


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190723 01	Location Context Map	A3	1: 50,000		
190723 02	Site Location Map	A3	1: 20,000		
190723– 02a	Site Notice Location Map A	A3	1:2,500		
190723- 02b	Site Notice Location Map B	A3	1:2,500		
190723- 02c	Site Notice Location Map C	A3	1:2,500		
190723- 02d	Site Notice Location Map D	A3	1:2,500		
190723- 02e	Site Notice Location Map E	A3	1:2,500		
190723- 02f	Site Notice Location Map F	A3	1:2,500		
190723- 02g 190723- 02h	Site Notice Location Map G Site Notice Location Map H	A3 A3	1:2,500 1:2,500		
190723- 02ii	Site Notice Location Map I	A3	1:2,500		
190723- 03	Site Layout Key Plan (1:5,000)	A3	1: 20,000		
190723- 04	Site Layout Sheet 1 of 2	A1	1: 5,000		
190723- 05	Site Layout Sheet 2 of 2	A1	1: 5,000		
190723- 06	Site Layout Key Plan (1:2,500)	A3	1: 20,000		
190723- 07	Site Layout Sheet 1 of 7	A1	1: 2,500		
190723- 08	Site Layout Sheet 2 of 7	A1	1: 2,500		
190723- 09	Site Layout Sheet 3 of 7	A1	1: 2,500		
190723 10	Site Layout Sheet 4 of 7	A1	1: 2,500		
190723 11	Site Layout Sheet 5 of 7	A1	1: 2,500		
190723 12	Site Layout Sheet 6 of 7	A1	1: 2,500		
190723 13	Site Layout Sheet 7 of 7	A1	1: 2,500		
190723 14	Turbine 1 Layout Sheet	A1	1: 500		
190723– 15	Turbine 2 Layout Sheet	A1	1: 500		
190723– 16	Turbine 3 Layout Sheet	A1	1: 500		
190723– 17	Turbine 4 Layout Sheet	A1	1: 500		
190723– 18	Turbine 5 Layout Sheet	A1	1: 500		
190723– 19	Turbine 6 Layout Sheet	A1	1: 500		
190723 20	Turbine 7 Layout Sheet	A1	1: 500		
190723 21	Turbine 8 Layout Sheet	A1	1: 500		
190723 22	Turbine 9 Layout Sheet	A1	1: 500		
190723 23	Wind Turbine Elevation & Plan	A1	1: 500		
190723- 24	Gravity Foundations Details	A3	As Shown		
190723– 25	Bored Pile Foundations Details	A3	As Shown		
190723– 26	Driven Pile Foundations Details	A3	As Shown		
190723- 27	Temporary Construction Compound	A3	1: 500		
190723- 28	Met Mast	A3	1: 500		
190723- 29	Operational Signage Detail	A3	1: 20		
190723- 30	Wheel Wash Detail	A3	1: 50		
190723- 31	Field Gate Detail	A3	1: 20		
190723- 32	Site Office & Staff Facilities Detail	A3	1: 100		
190723- 34	Building for Demolition	A3	1: 100		
190723 - 35	Clear Span Watercourse Crossing	A3	1: 50		
190723- 36	Biodiversity Enhancement and Management Proposals	A3	1: 15,000		
190723– 37 190723– 38	Proposed Access Junction 1 Proposed Access Junction 2	A3 A3	1: 1,000 1: 1,000		
190723- 38	Proposed Access Junction 2 Proposed Access Junction 3	A3	1: 1,000		
190723- 39	Proposed Access Junction 4	A3	1: 1,000		
190723- 40	Proposed Access Junction 5	A3	1: 1,000		
190723 - 42	Temporary Boundary Treatment Works	A3	As Shown		
190723 - 43	33kv Cable Trench Sections	A3	1:10		
100720 10	our case french sections	110	1.10		
	Hydro Environmental Services (HES)				
P1611-0-0925-A1-D501-00B	Drainage Details 1	A1	As Shown		
P1611-0-0925-A1-D502-00B	Drainage Details 2	A1	As Shown		
P1611-0-0925-A1-D503-00B	Drainage Details 3	A1	As Shown		
P1611-0-0925-A1-D101-00B	D101 Proposed Drainage Layout	A1	1: 2,000		
P1611-0-0925-A1-D102-00B	D102 Proposed Drainage Layout	A1	1: 2,000		
P1611-0-0925-A1-D103-00B	D103 Proposed Drainage Layout	A1	1: 2,000		
P1611-0-0925-A1-D104-00B	D104 Proposed Drainage Layout	A1	1: 2,000		
P1611-0-0925-A1-D105-00B	D105 Proposed Drainage Layout	A1	1: 2,000		
Cavin & Dobarty Coordinations (CDC)					
	Gavin & Doherty Geosolutions (GDG)				
			T T T T T T T T T T T T T T T T T T T		
99008 CDC 77 VV DD C 0100	Access Road Standard Datails	Δ1	1.95		
22098-GDG-ZZ-XX-DR-C-0100 22098-GDG-ZZ-XX-DR-C-0101	Access Road Standard Details  Peat and Spoil Repository Area Typical Details	A1 A1	1: 25 As Shown		

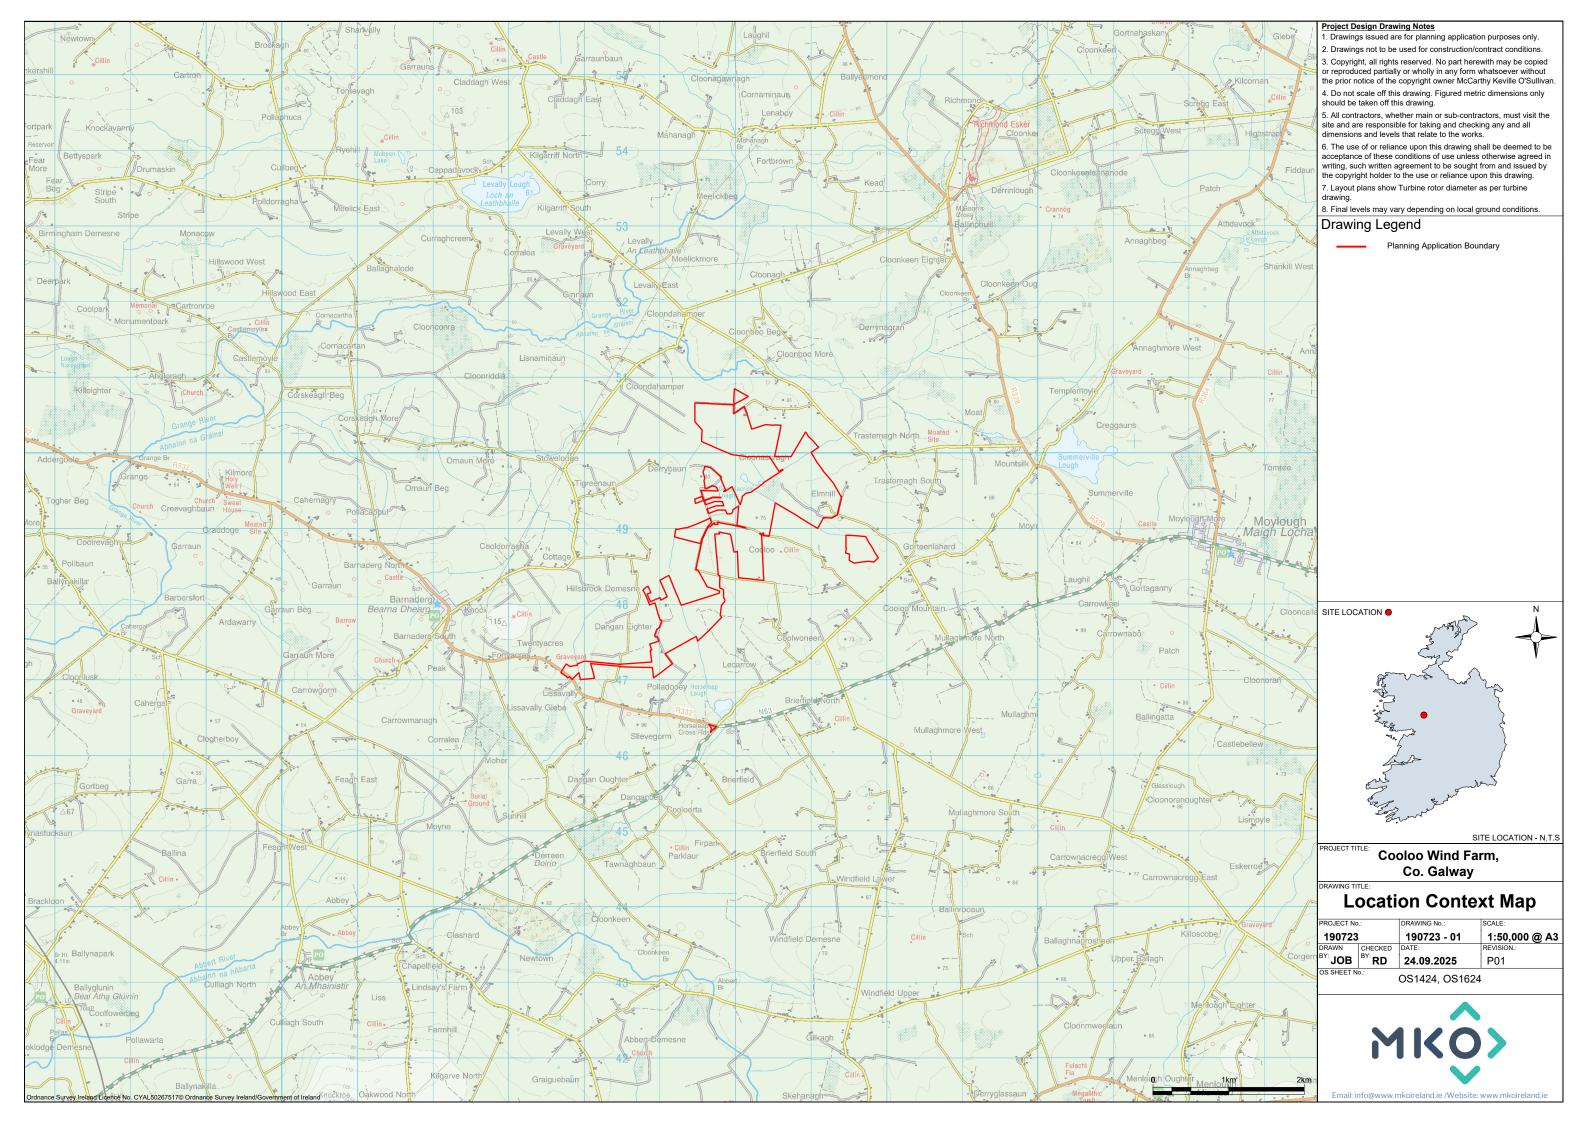


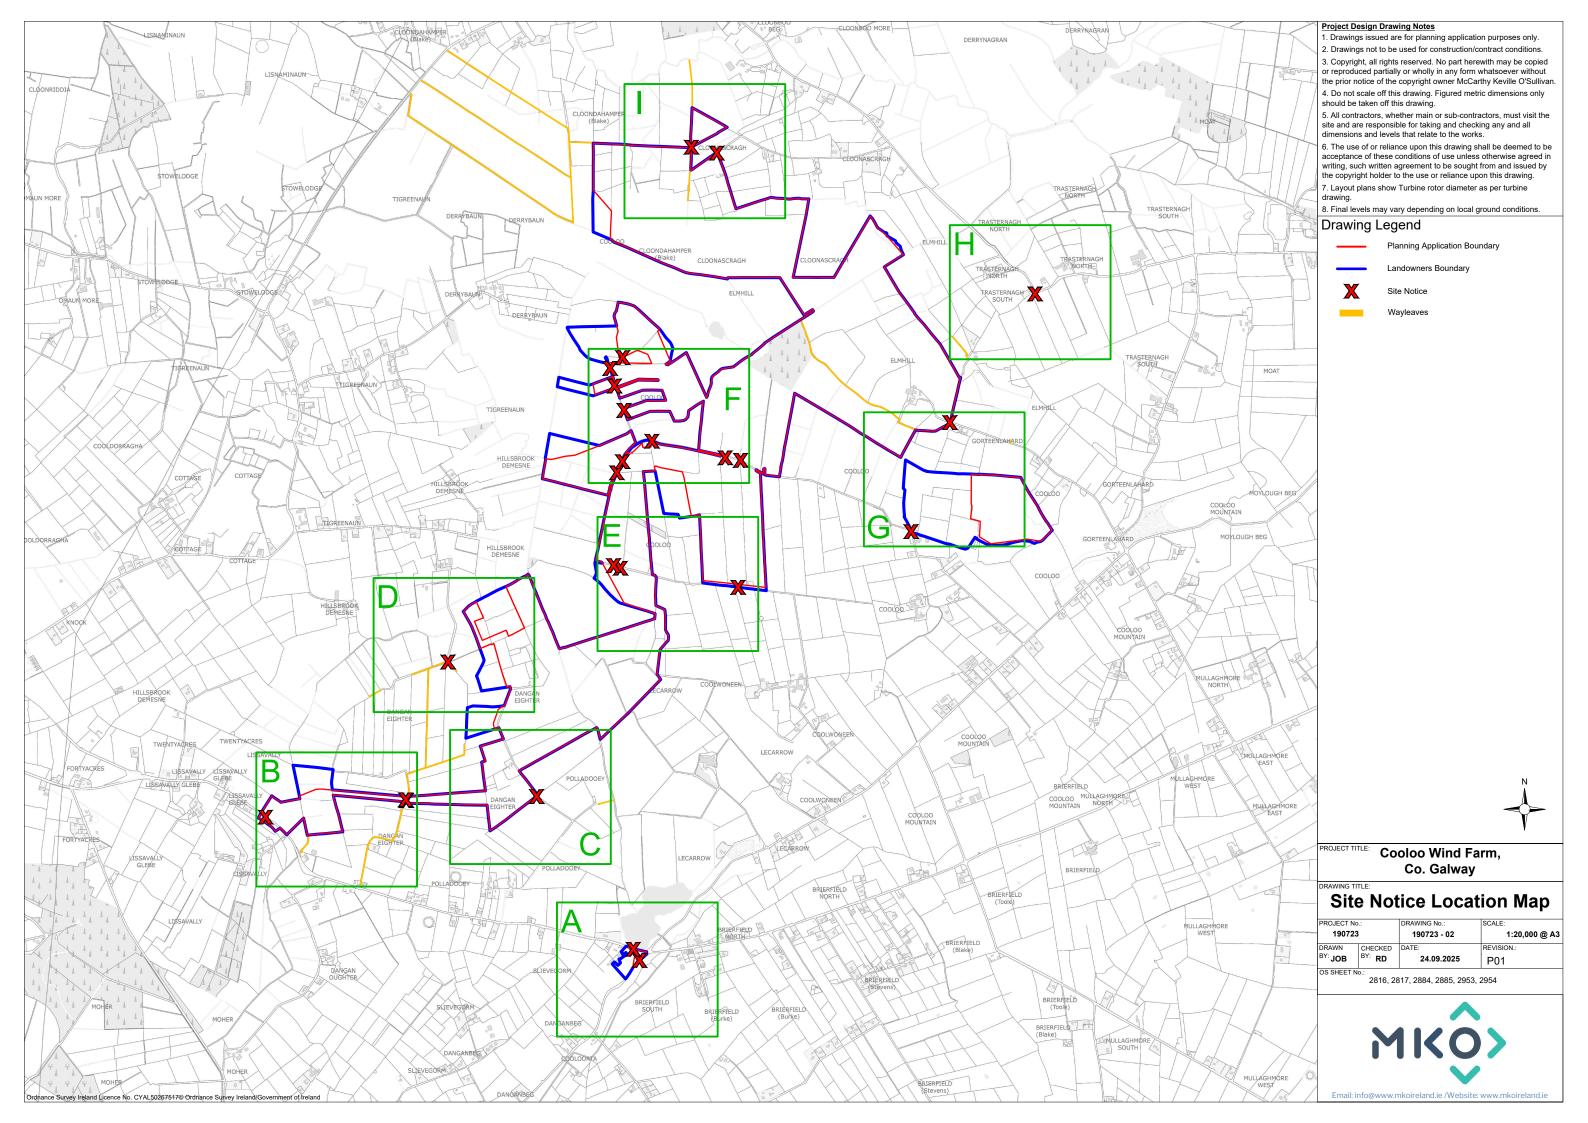


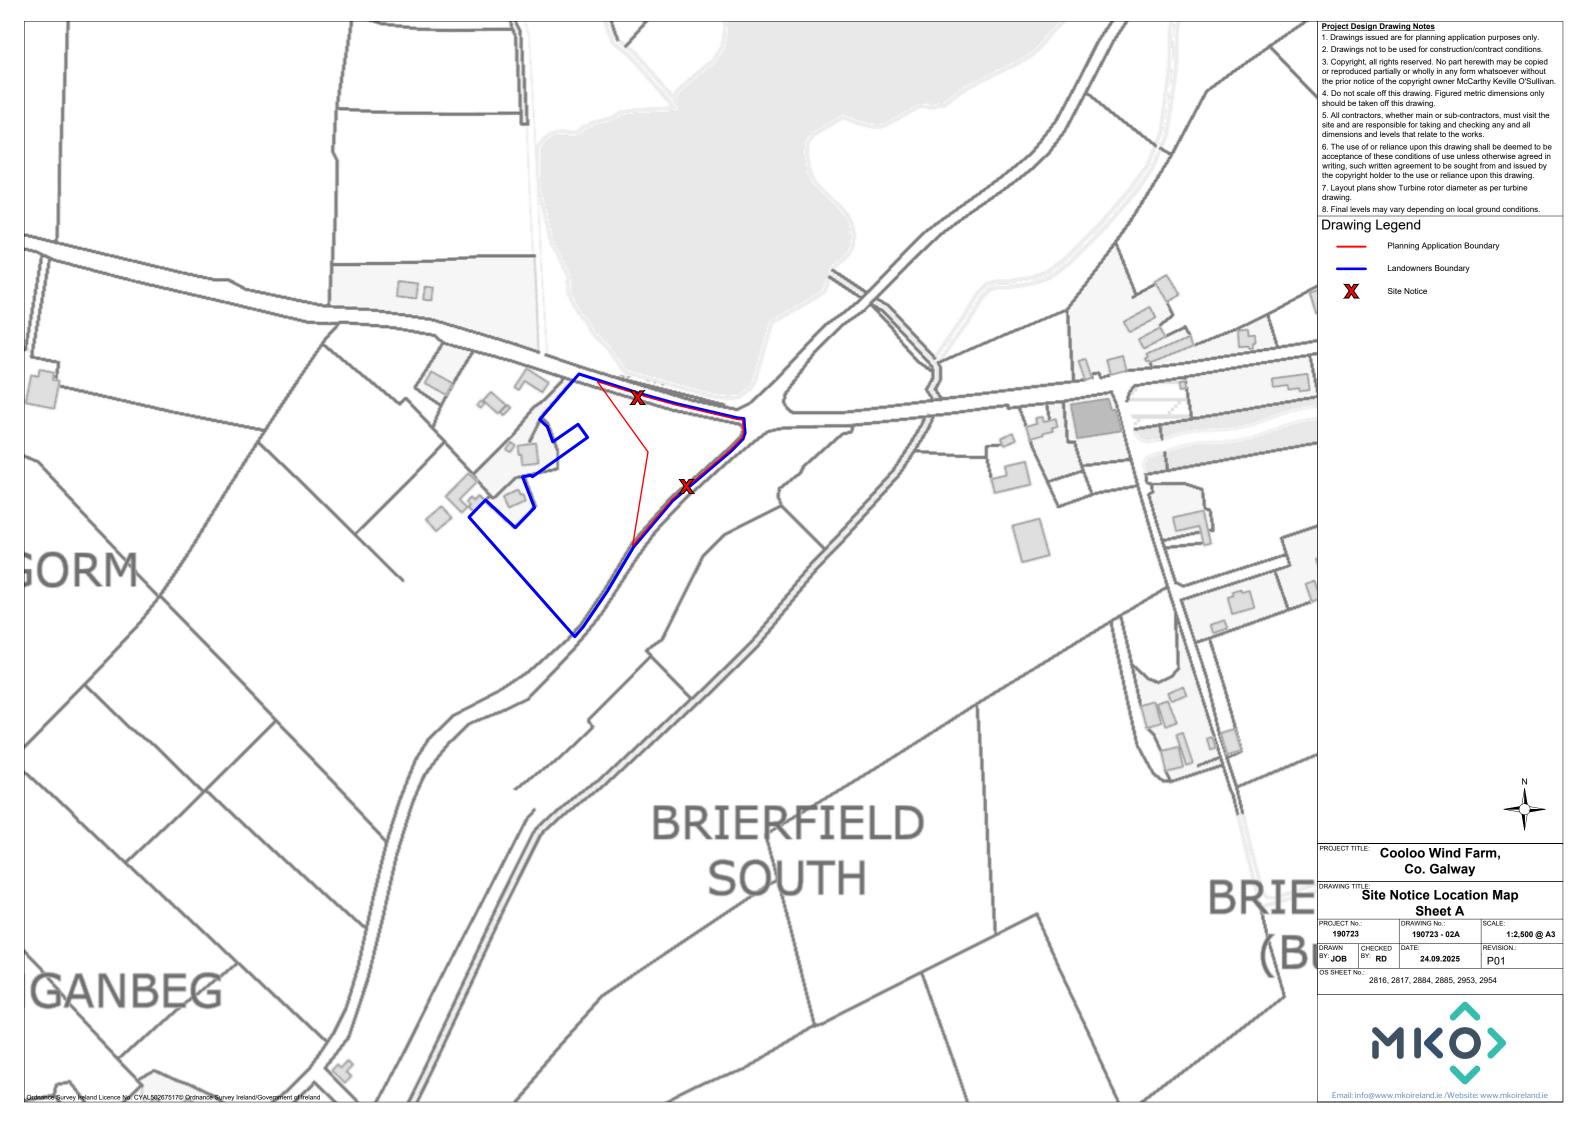


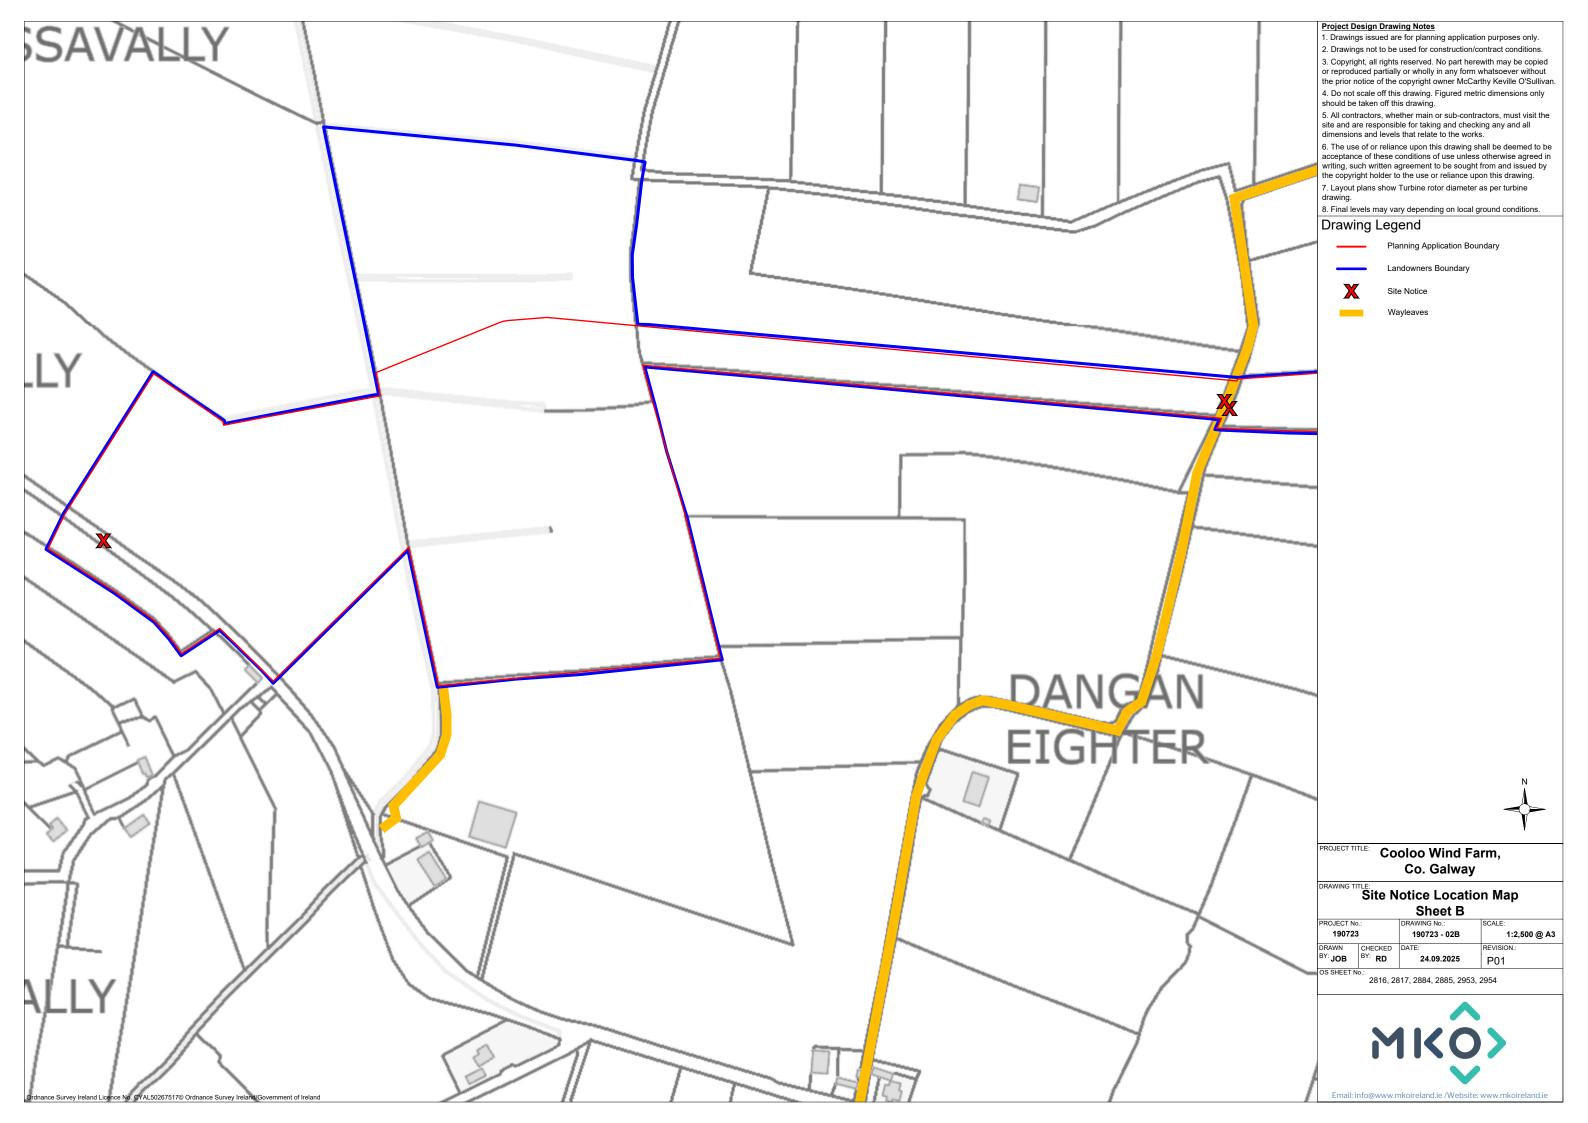


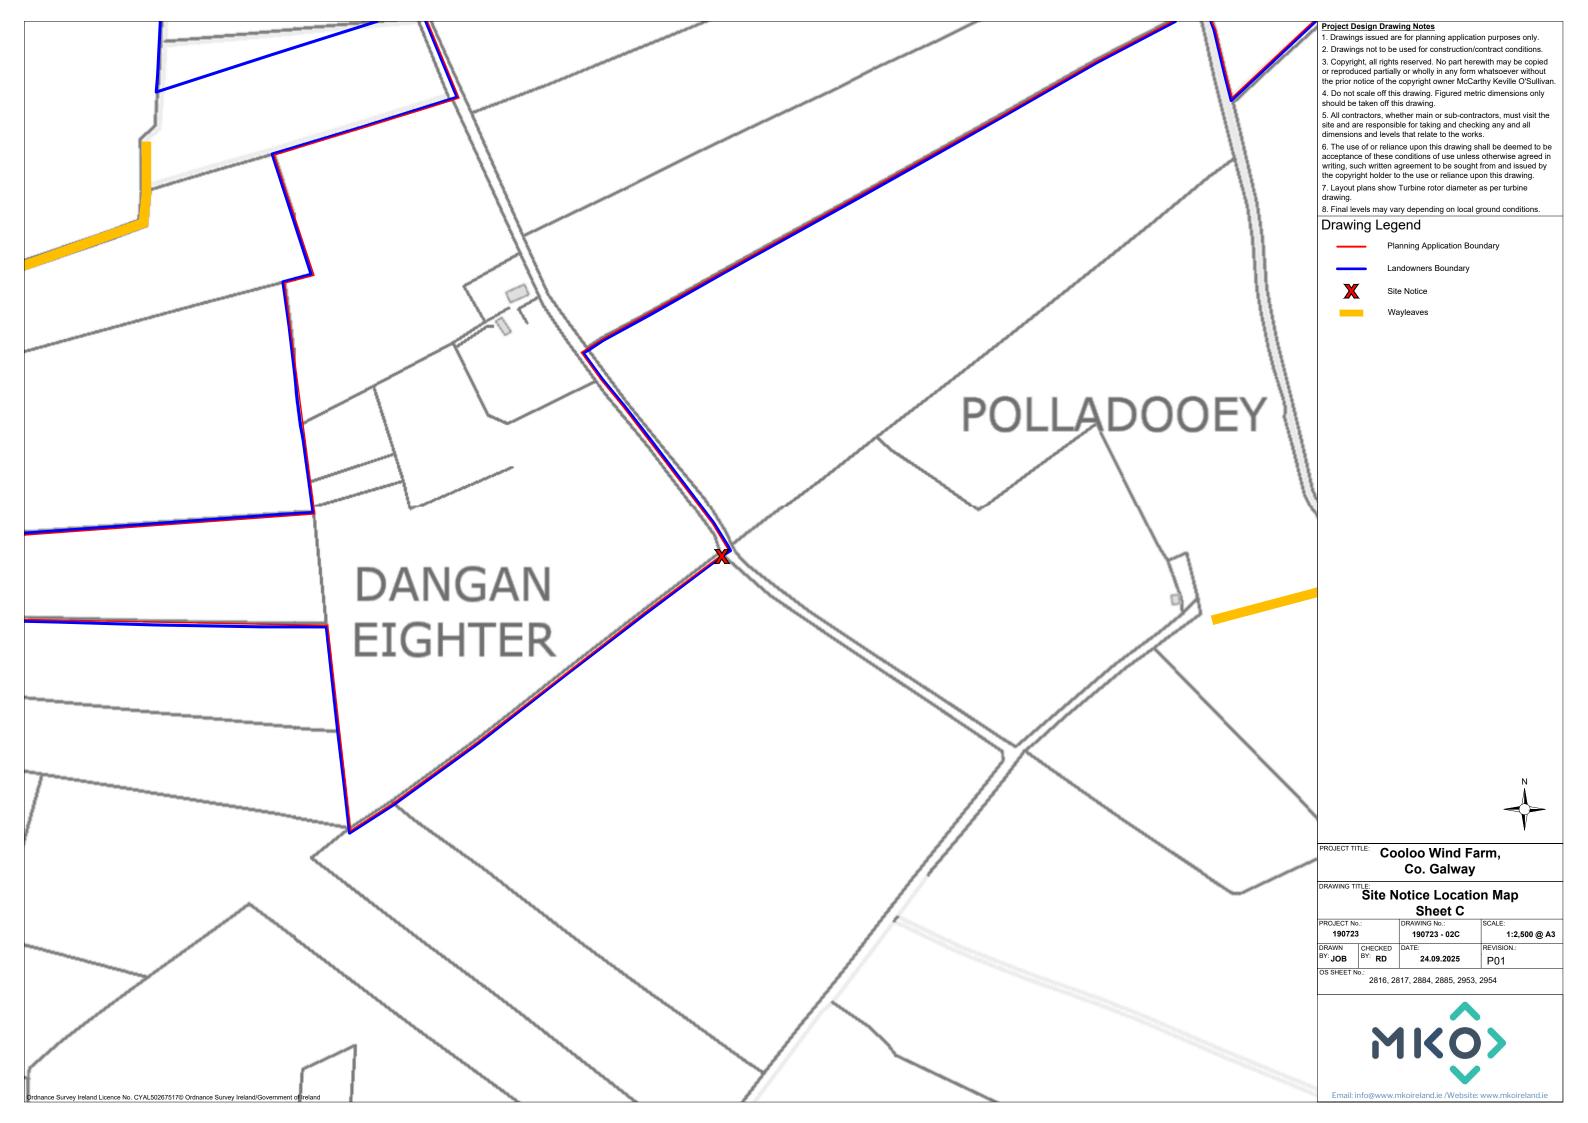


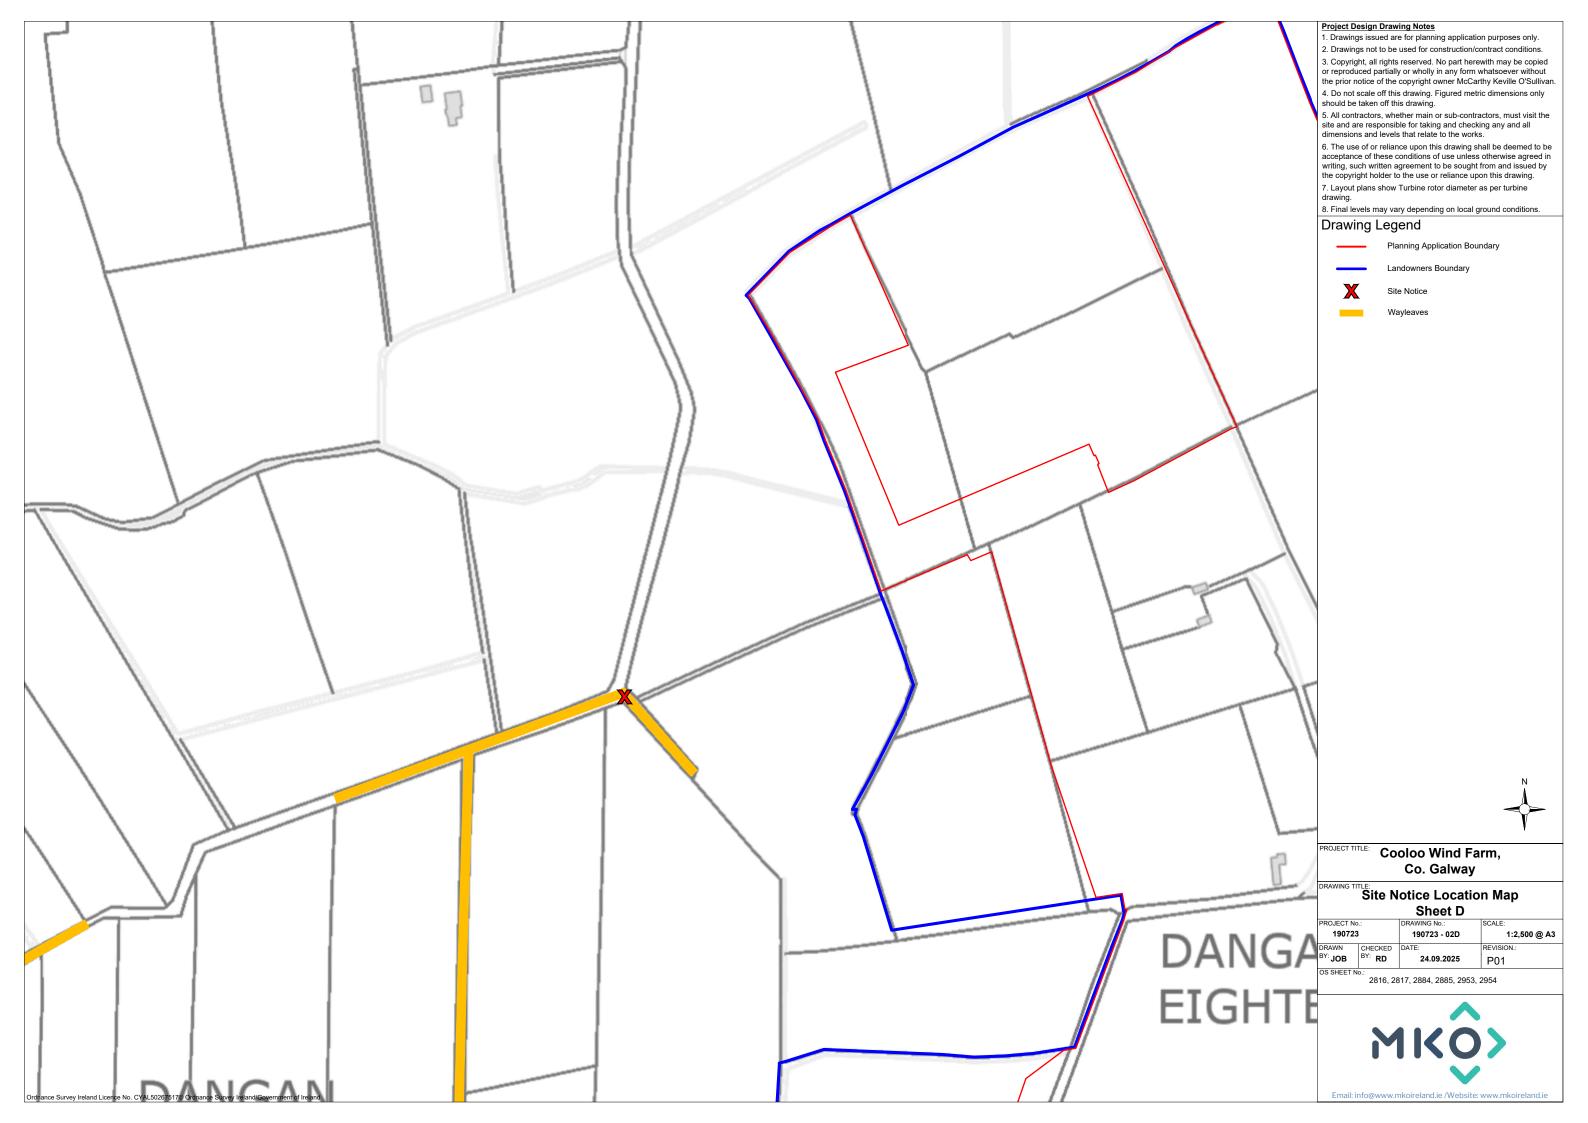


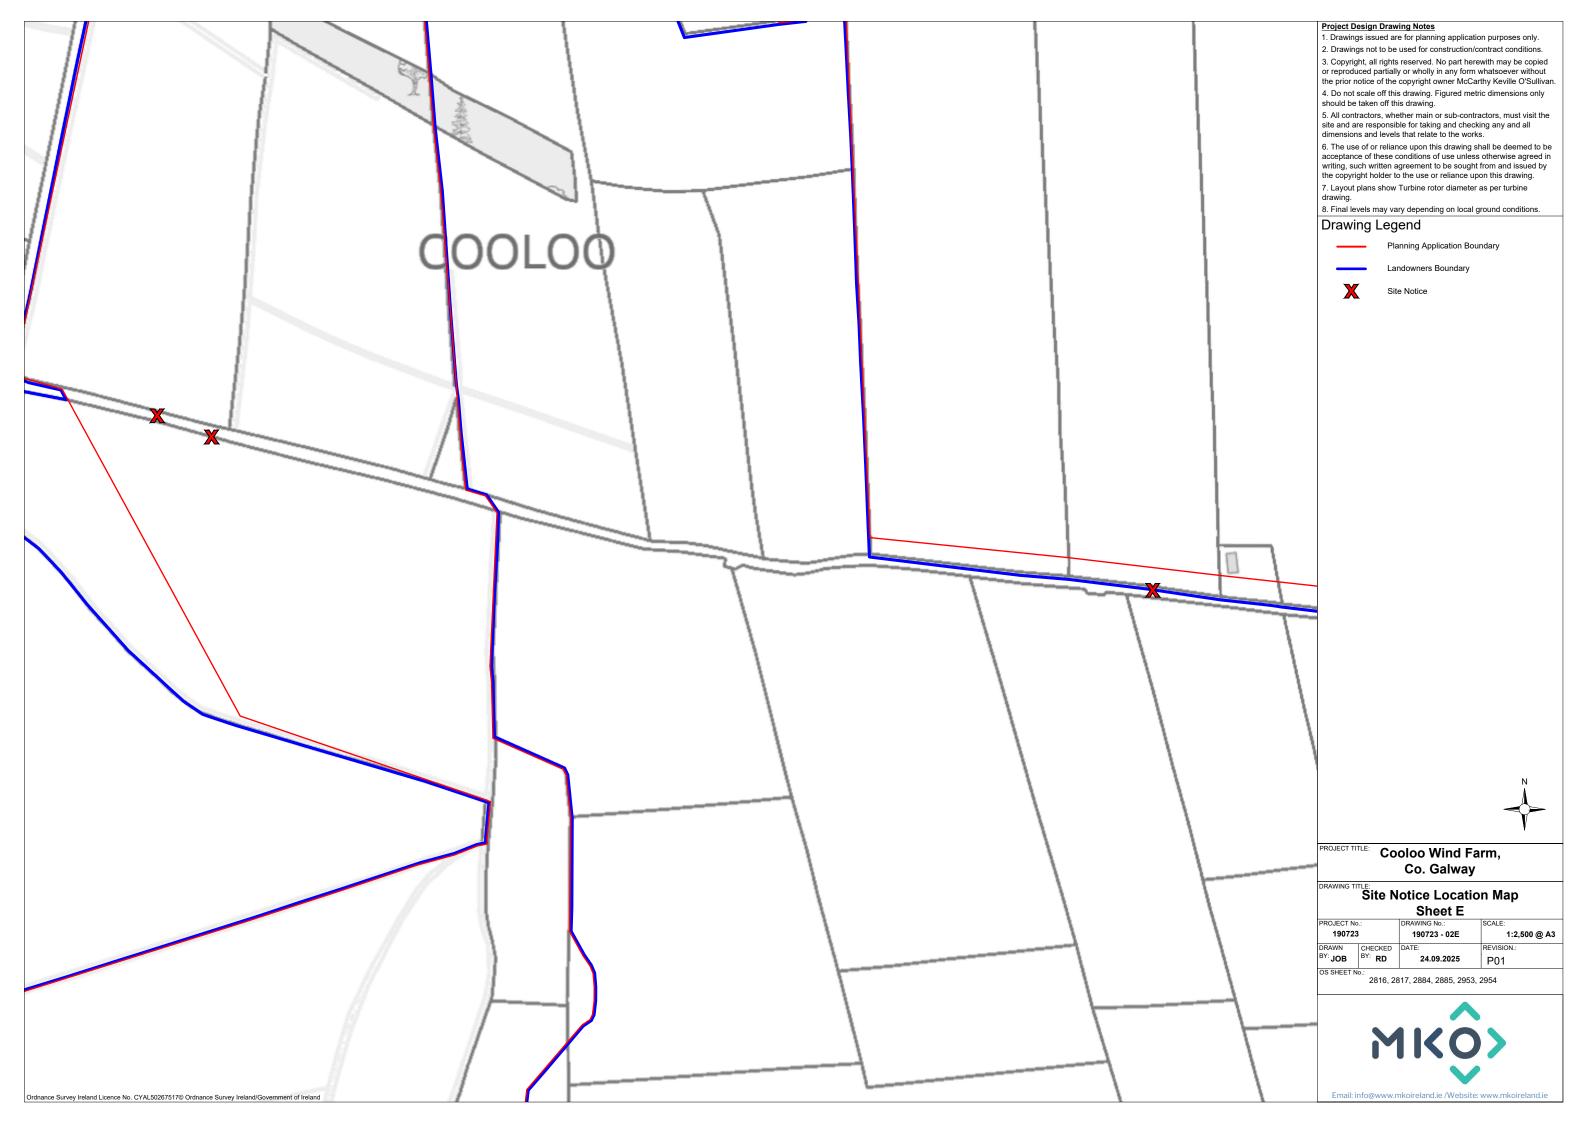


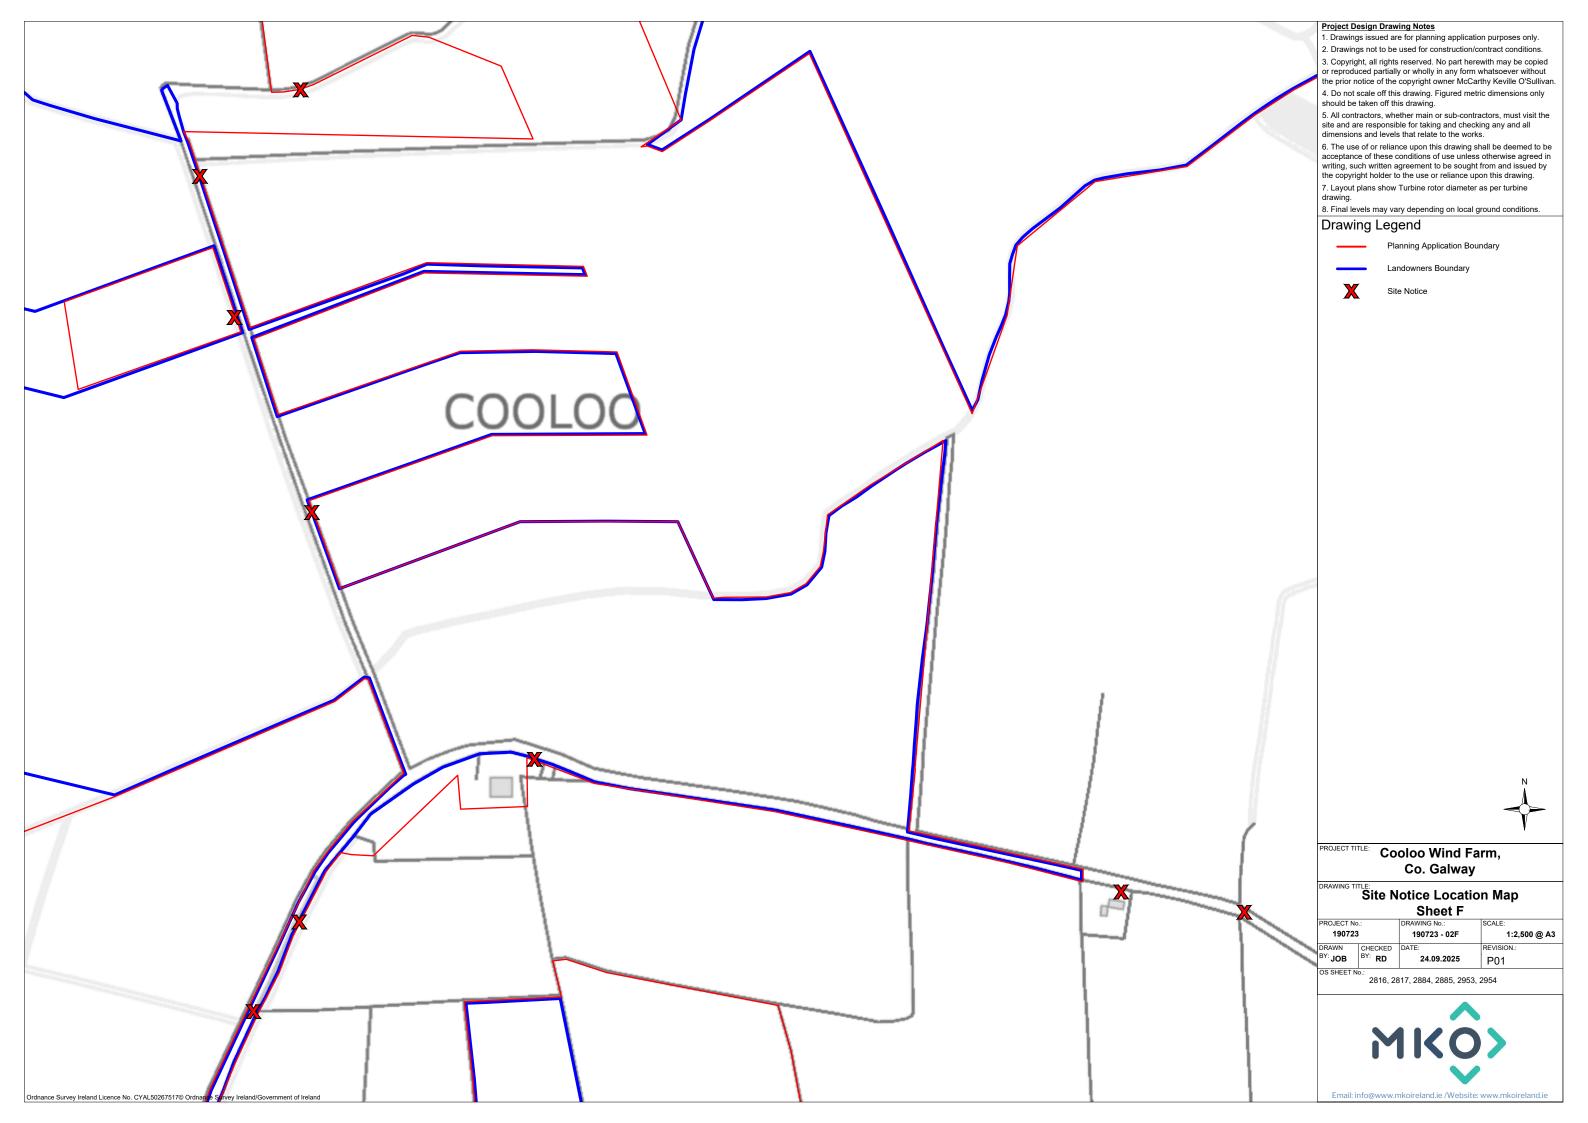


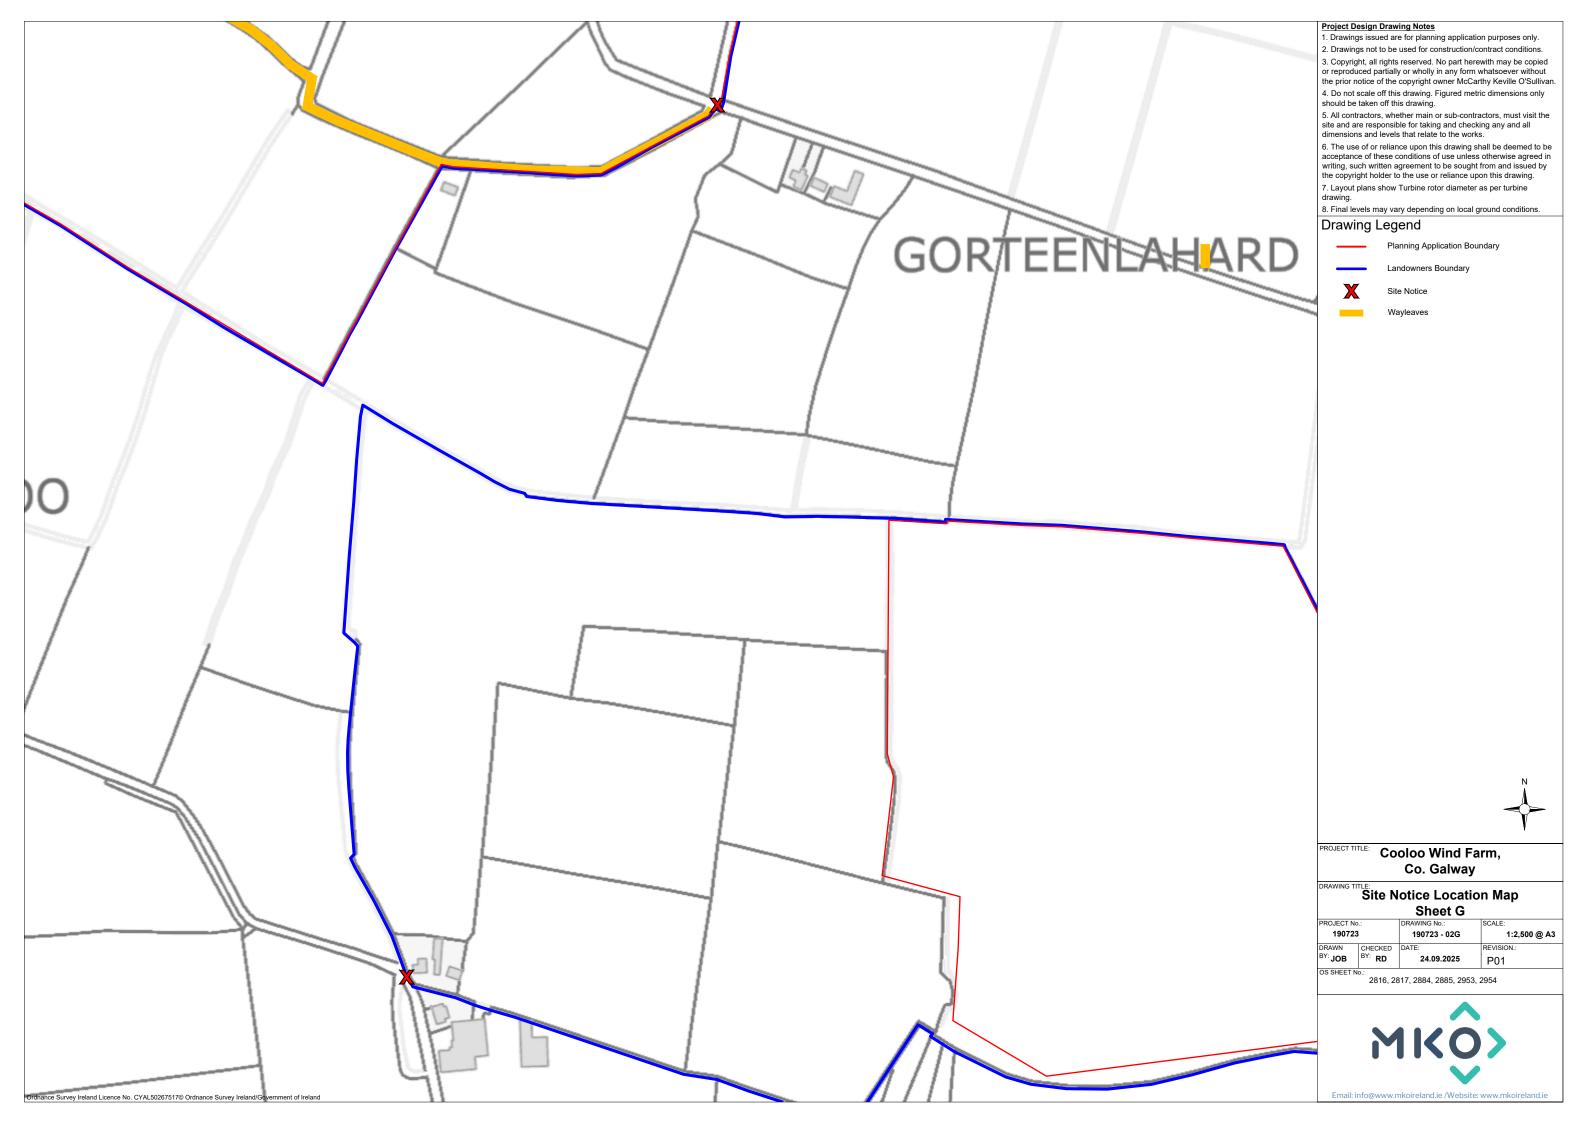


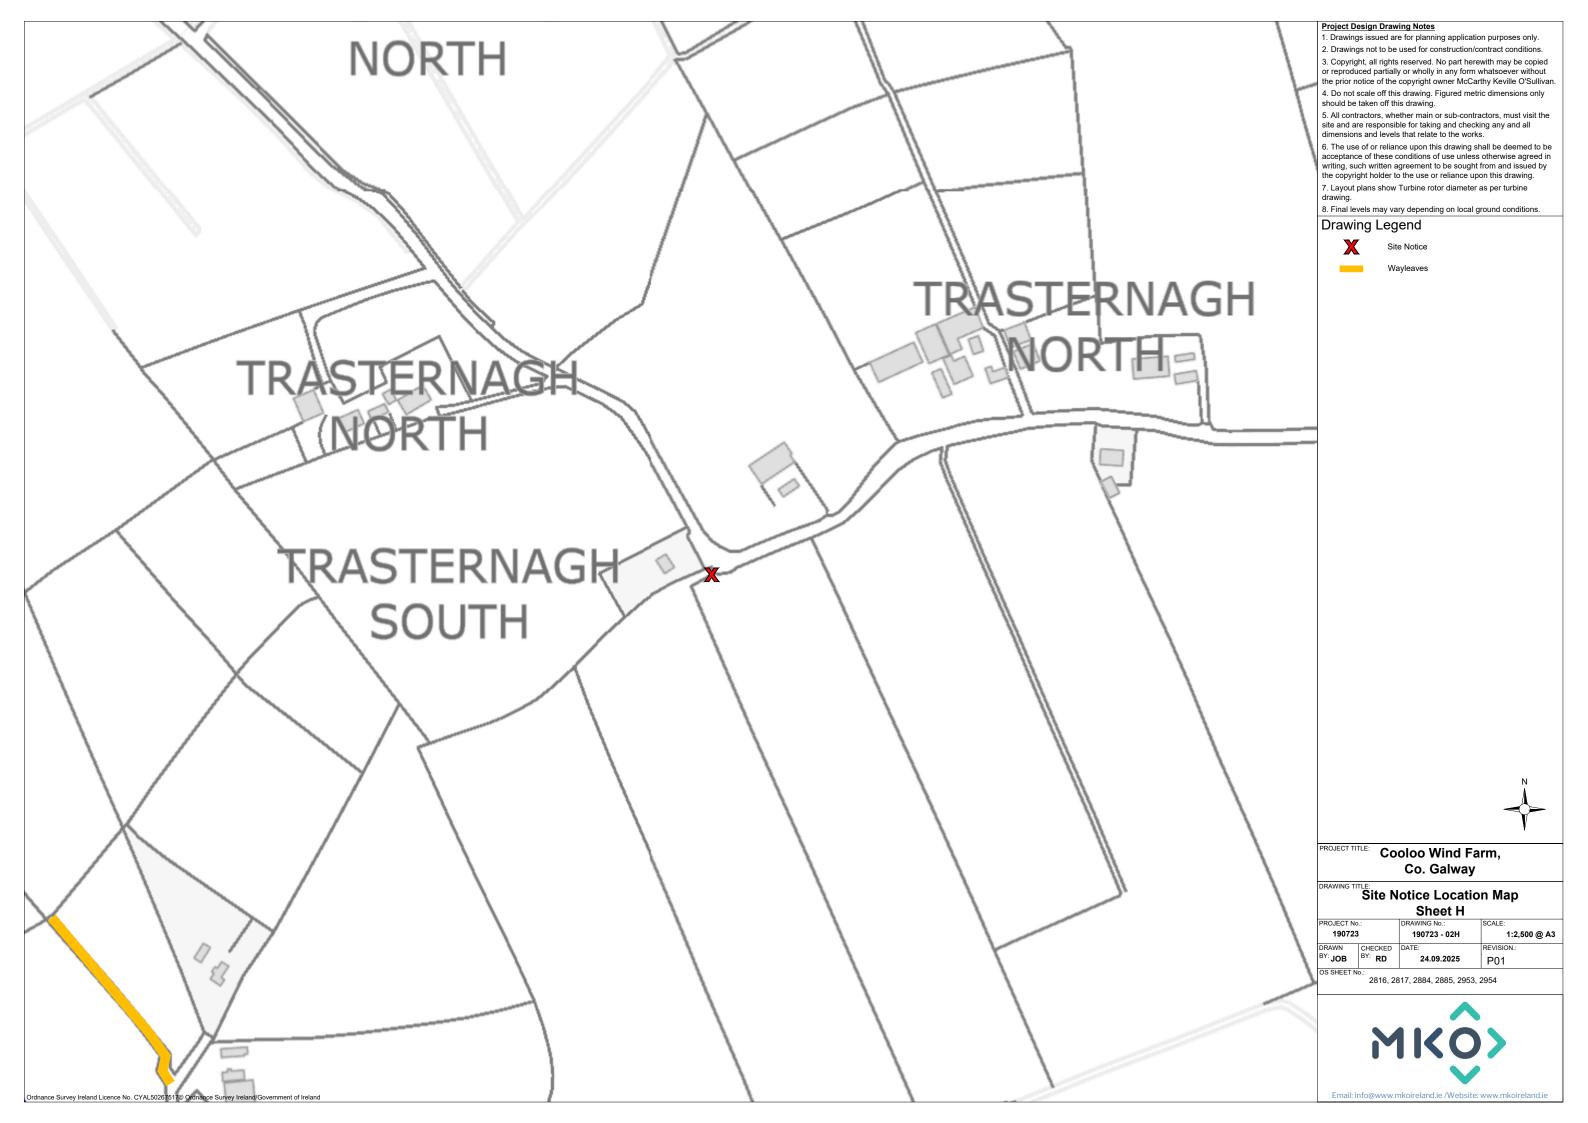


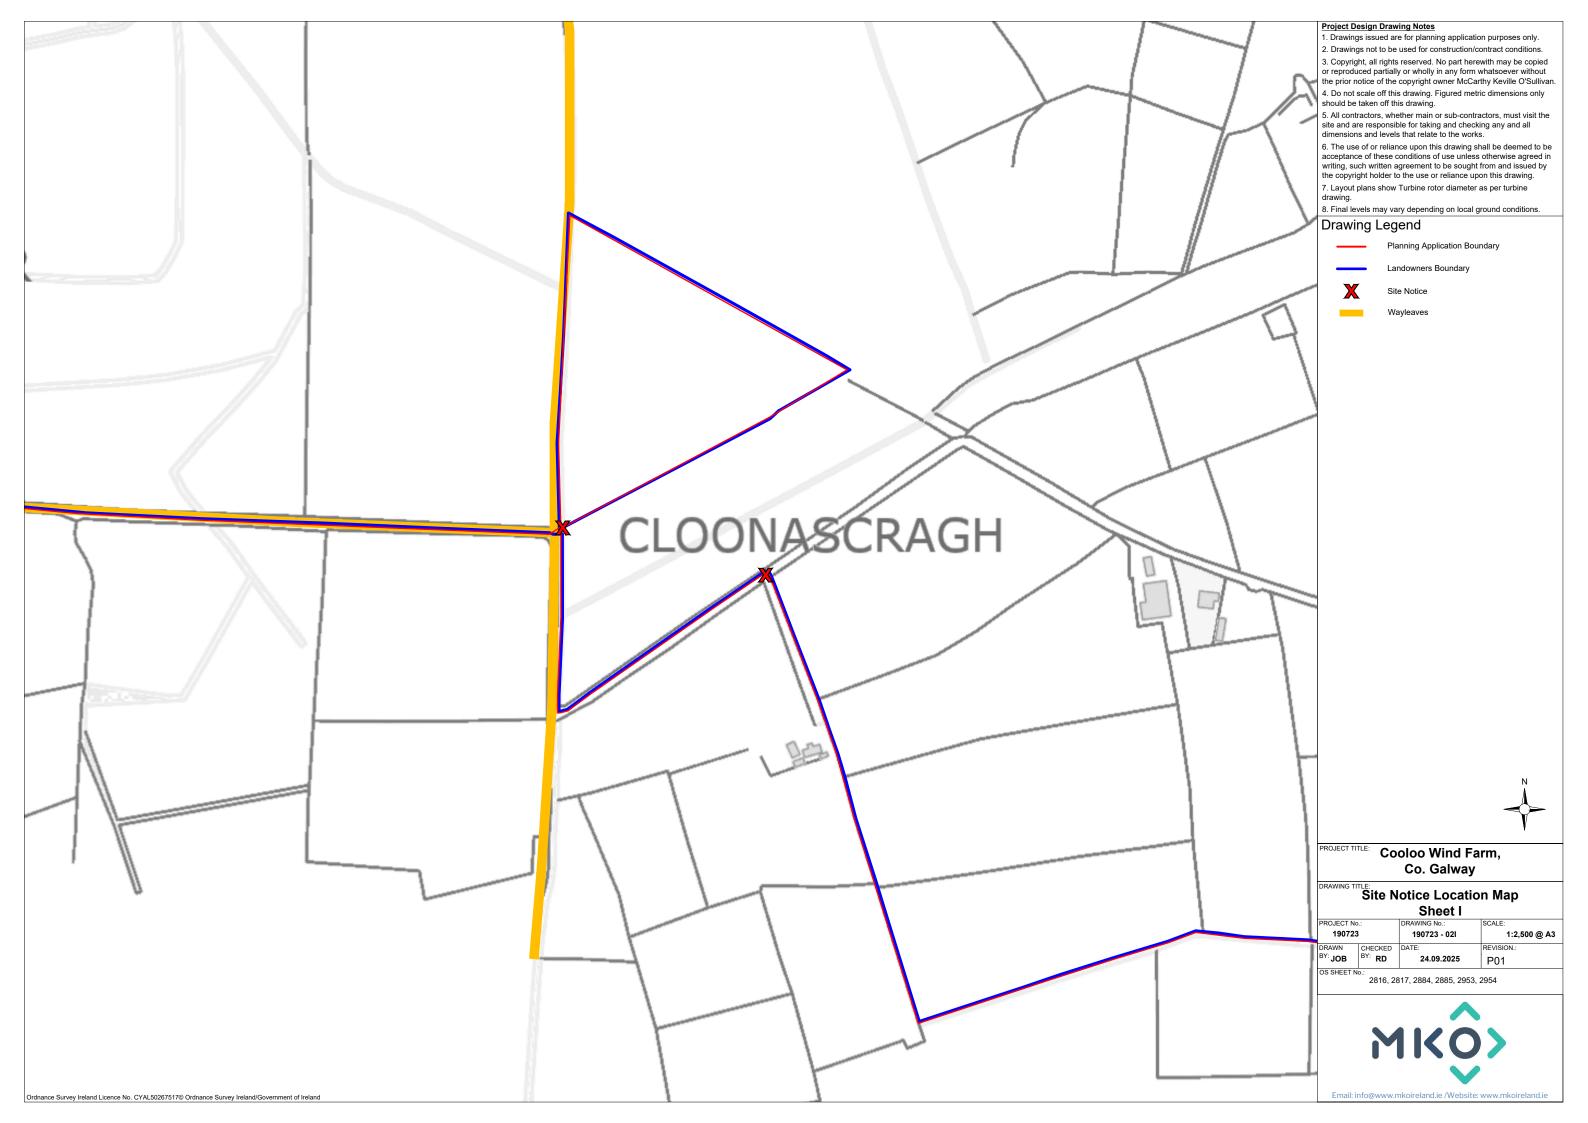


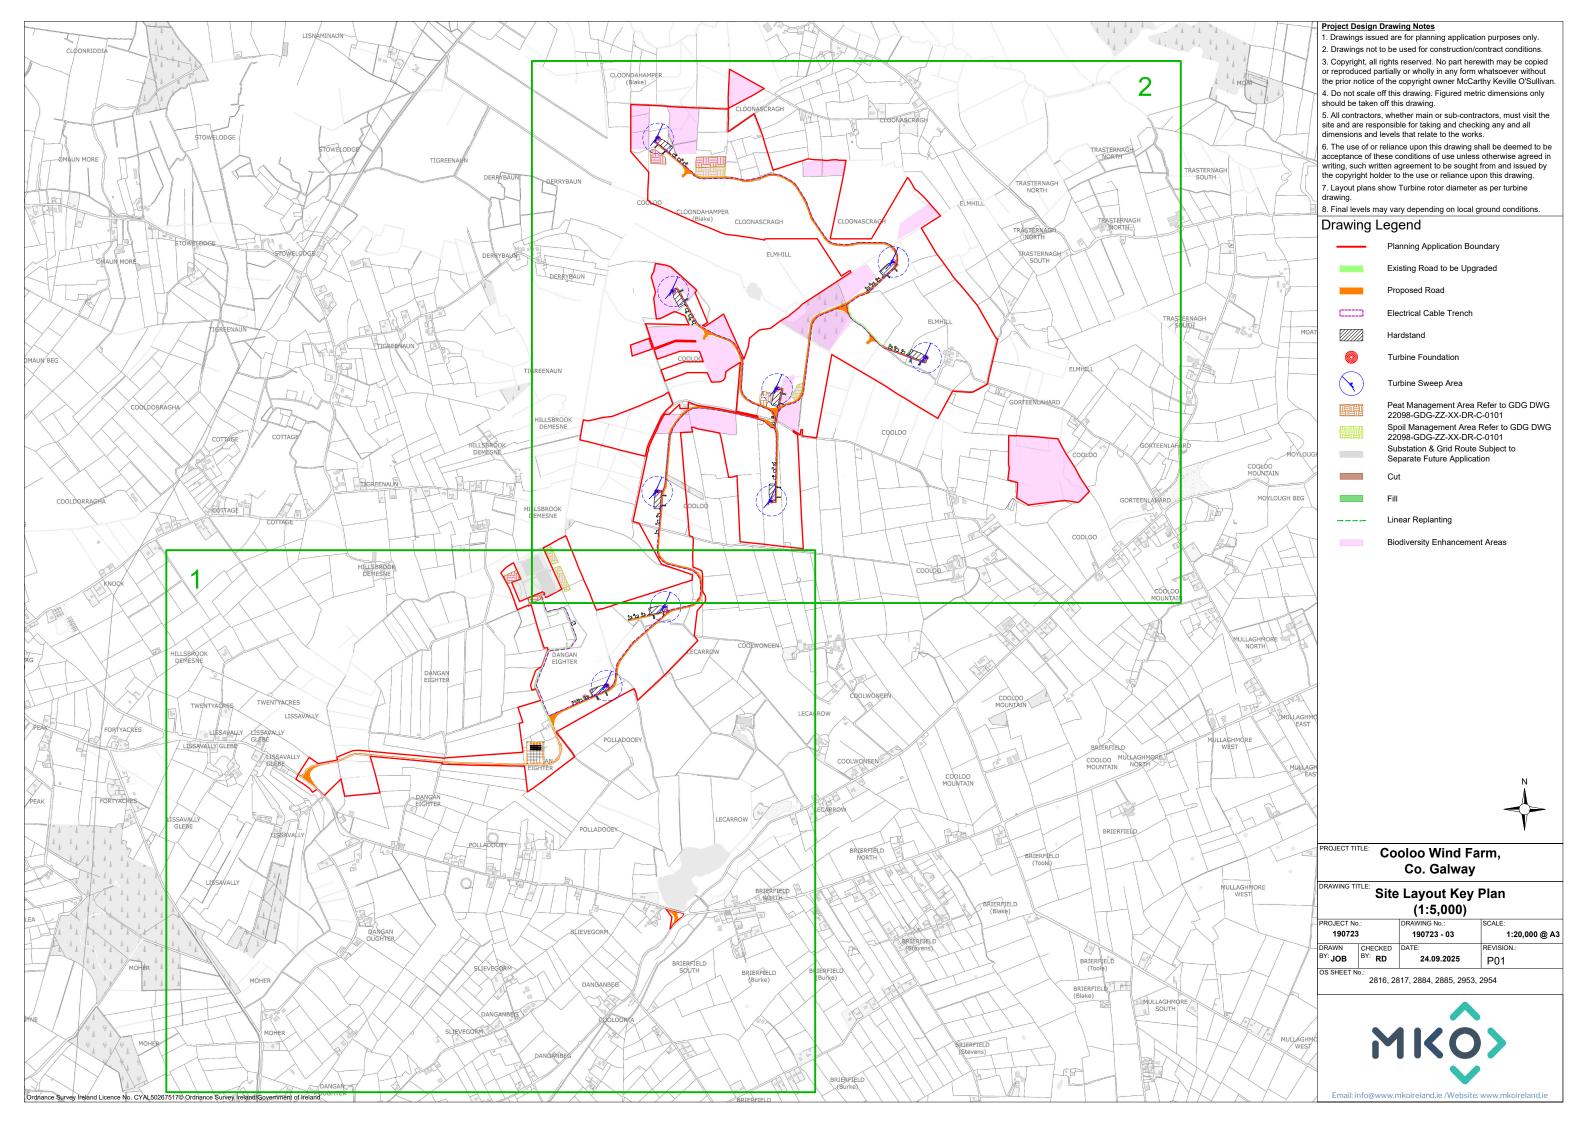

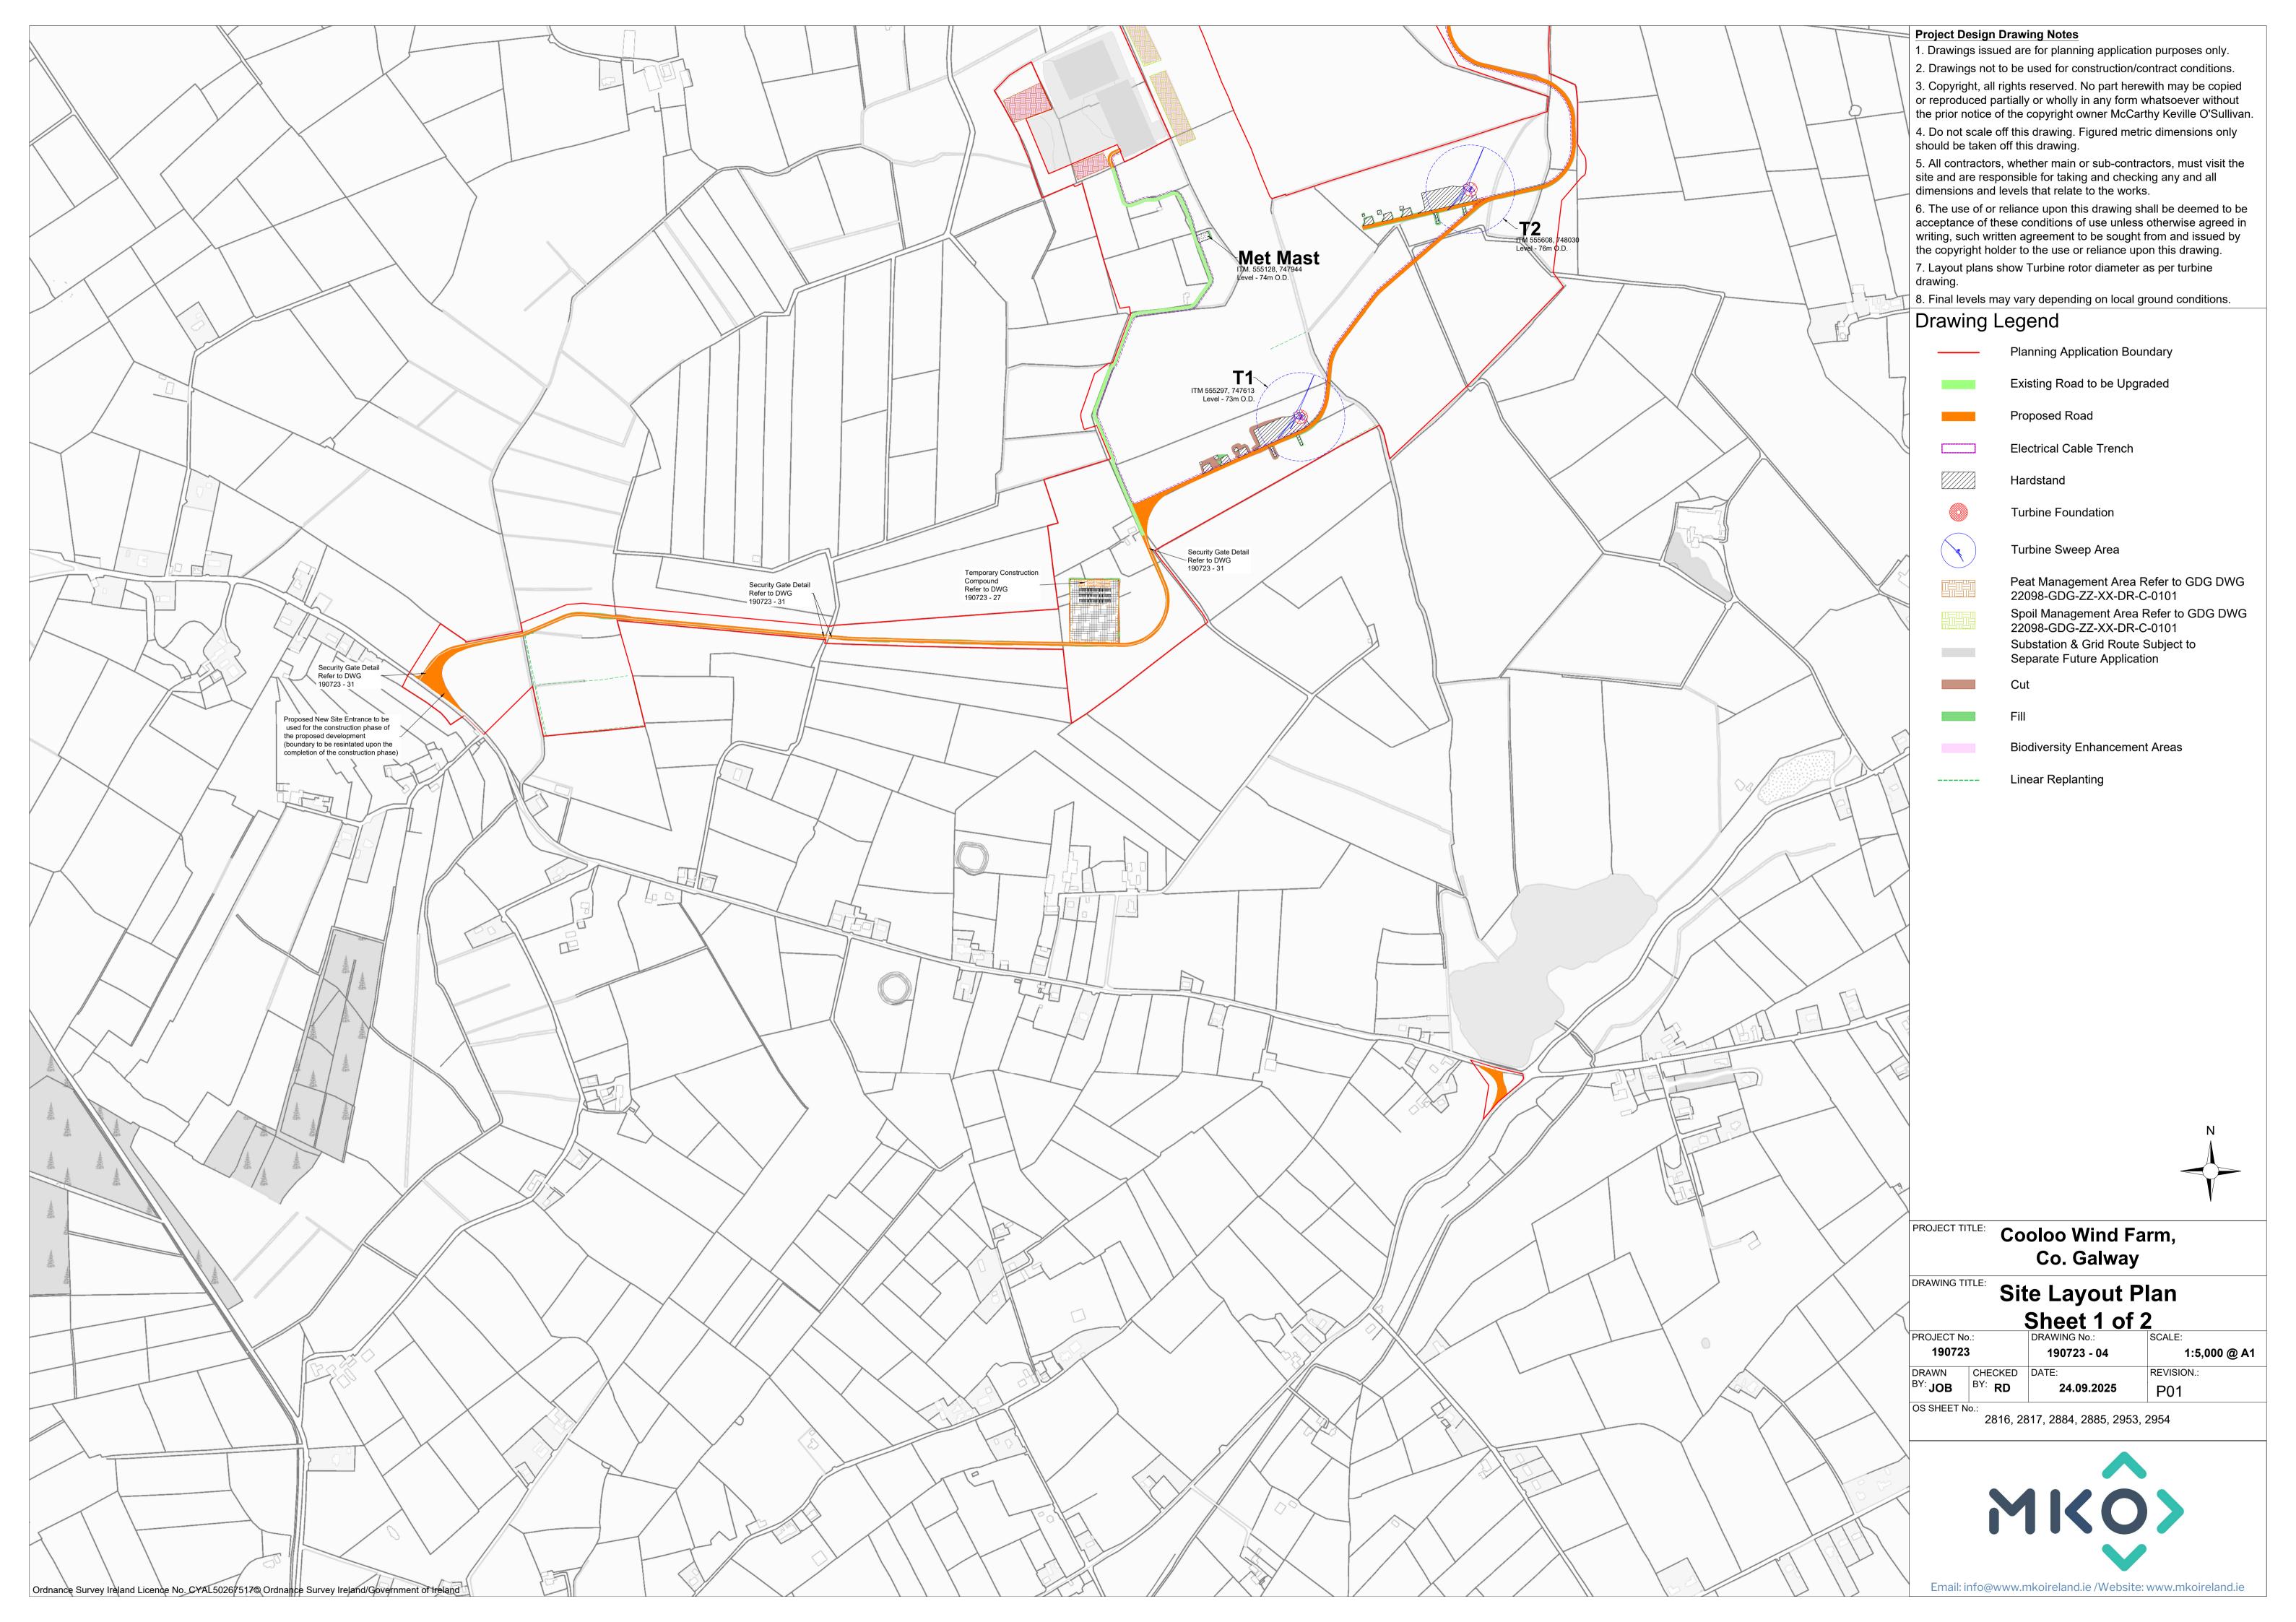


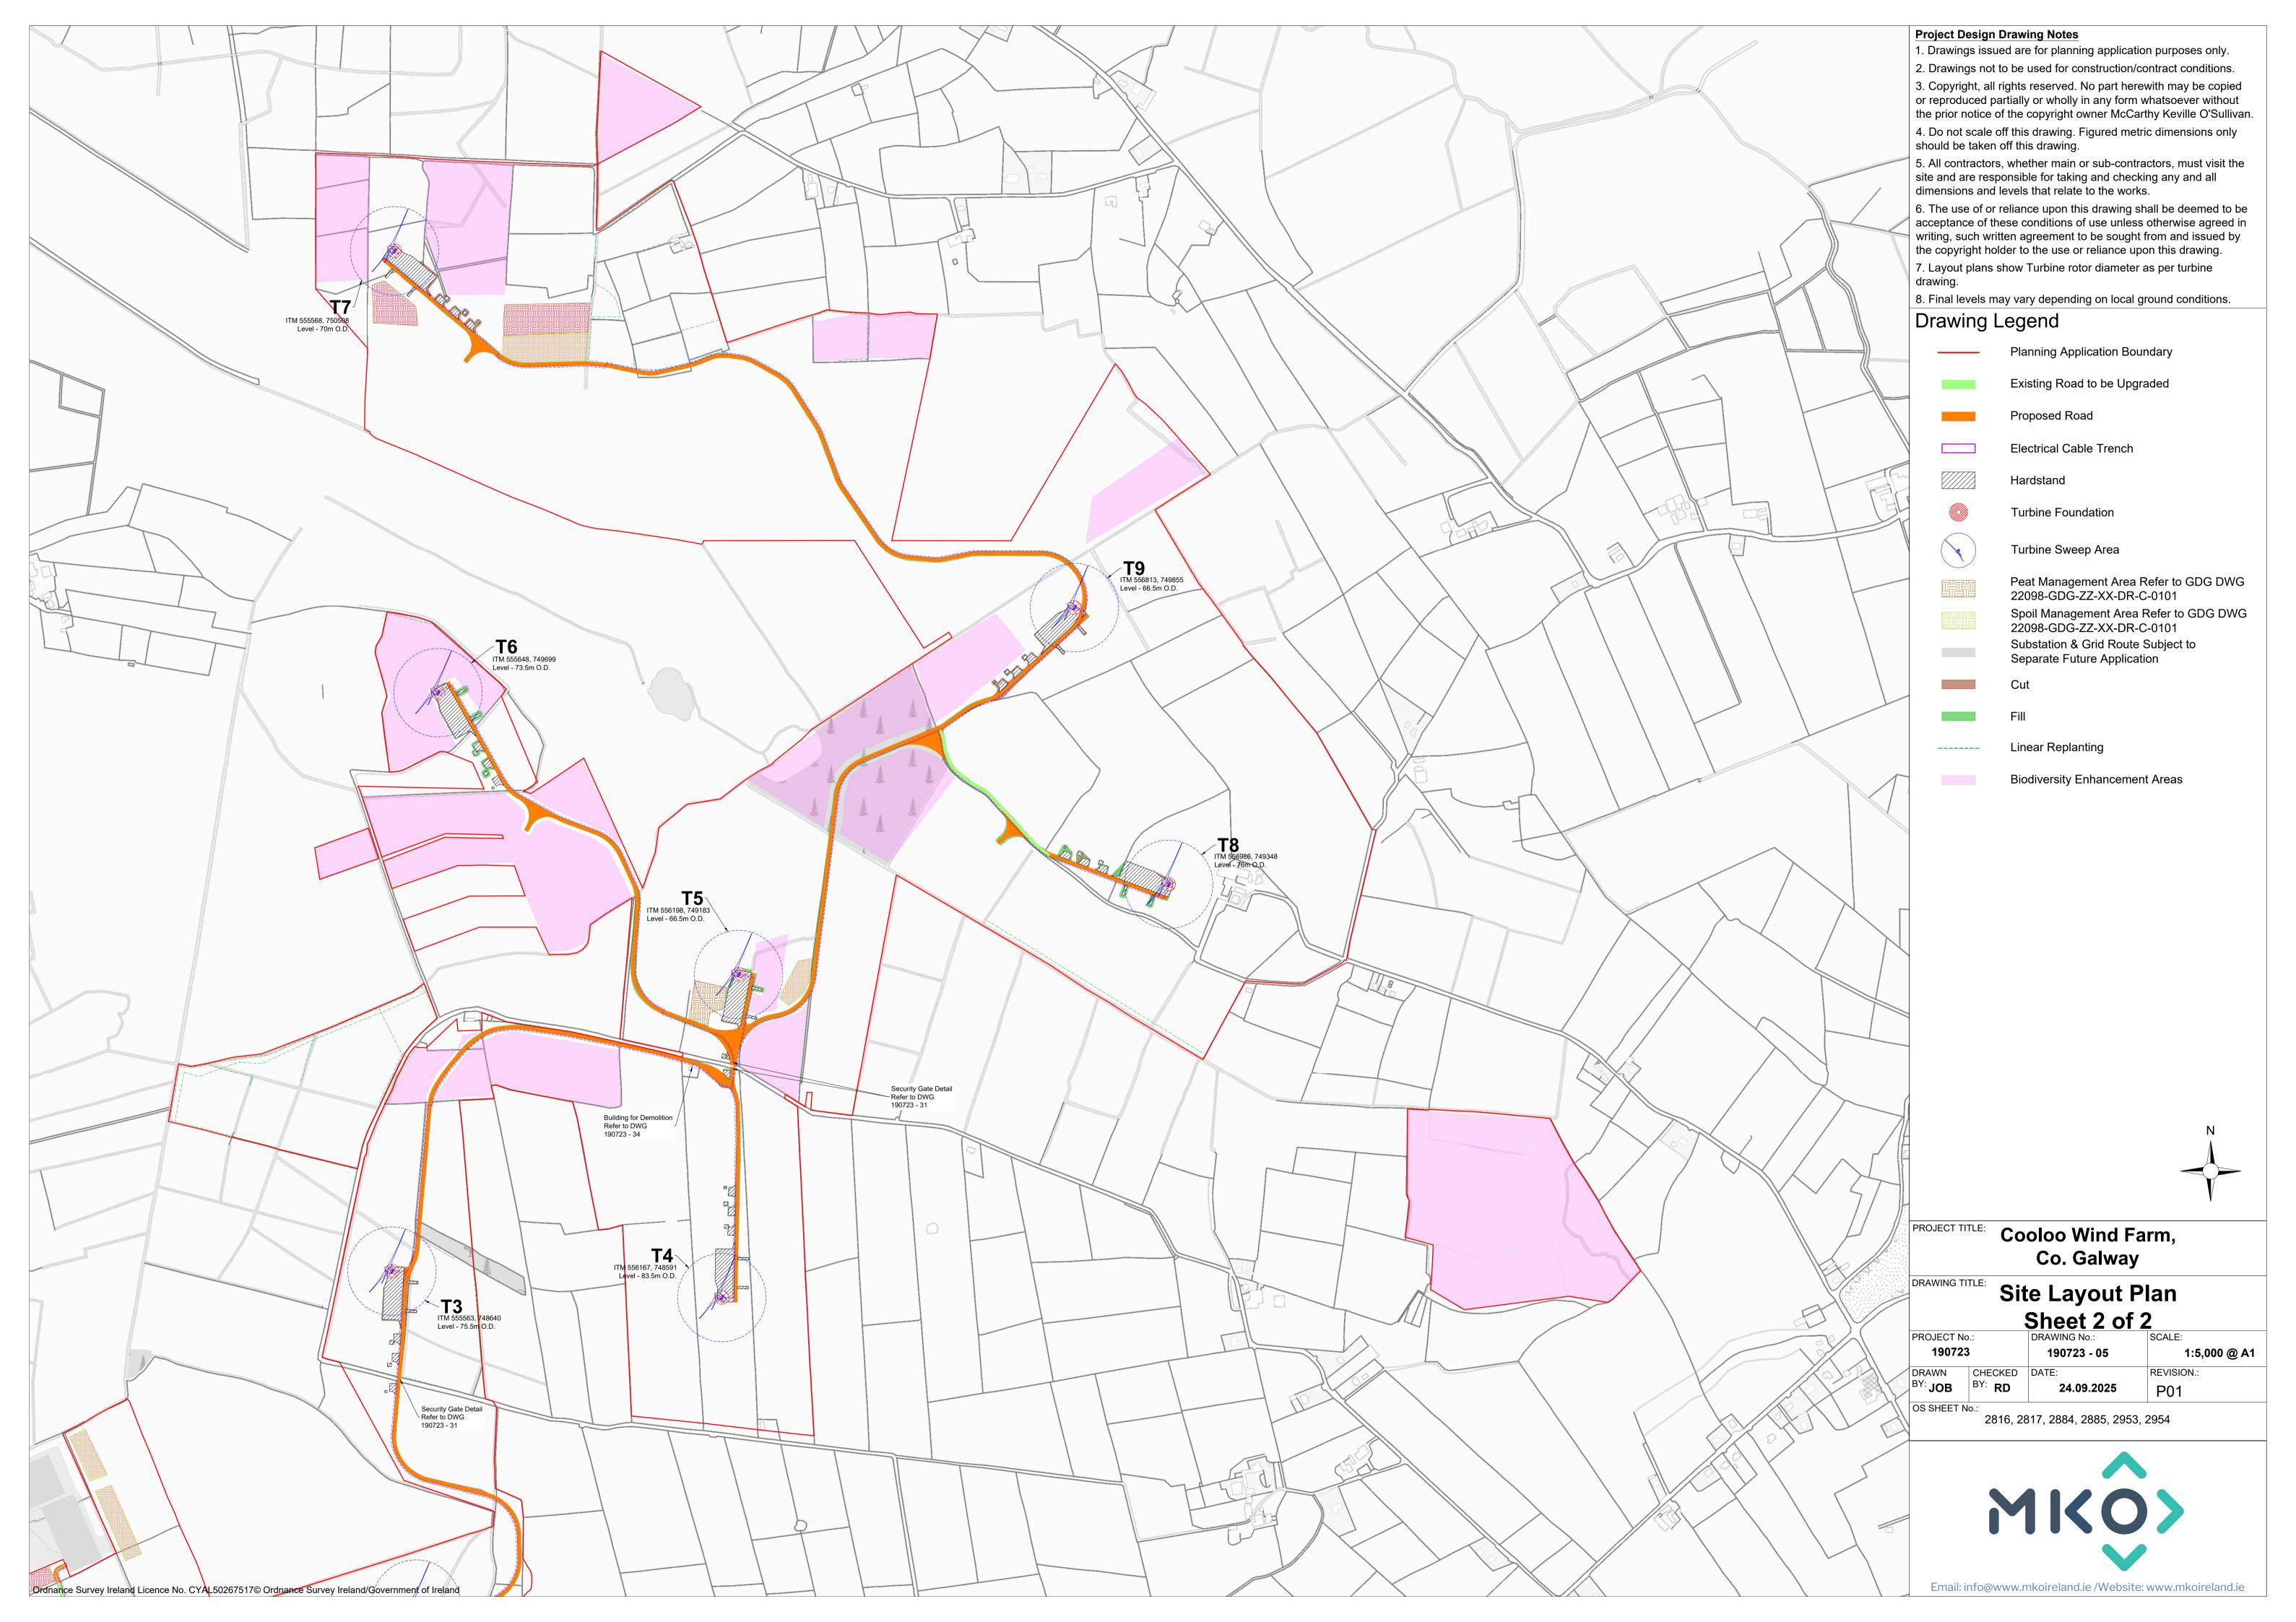


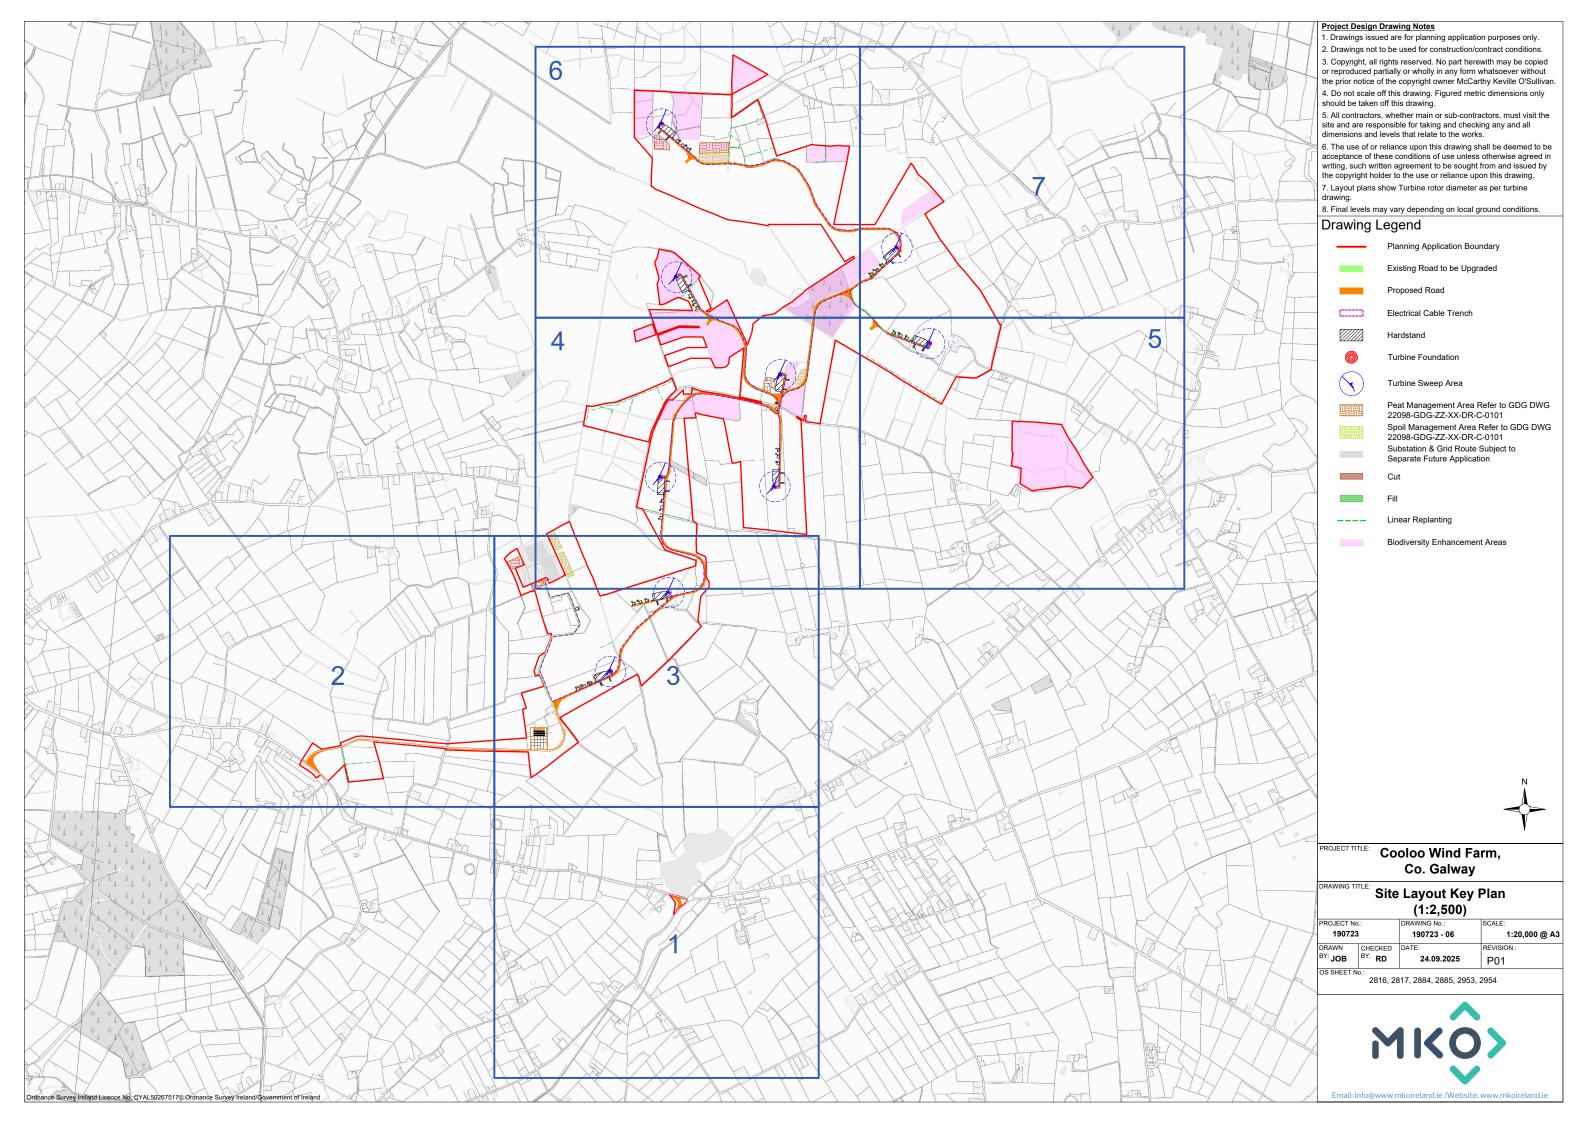


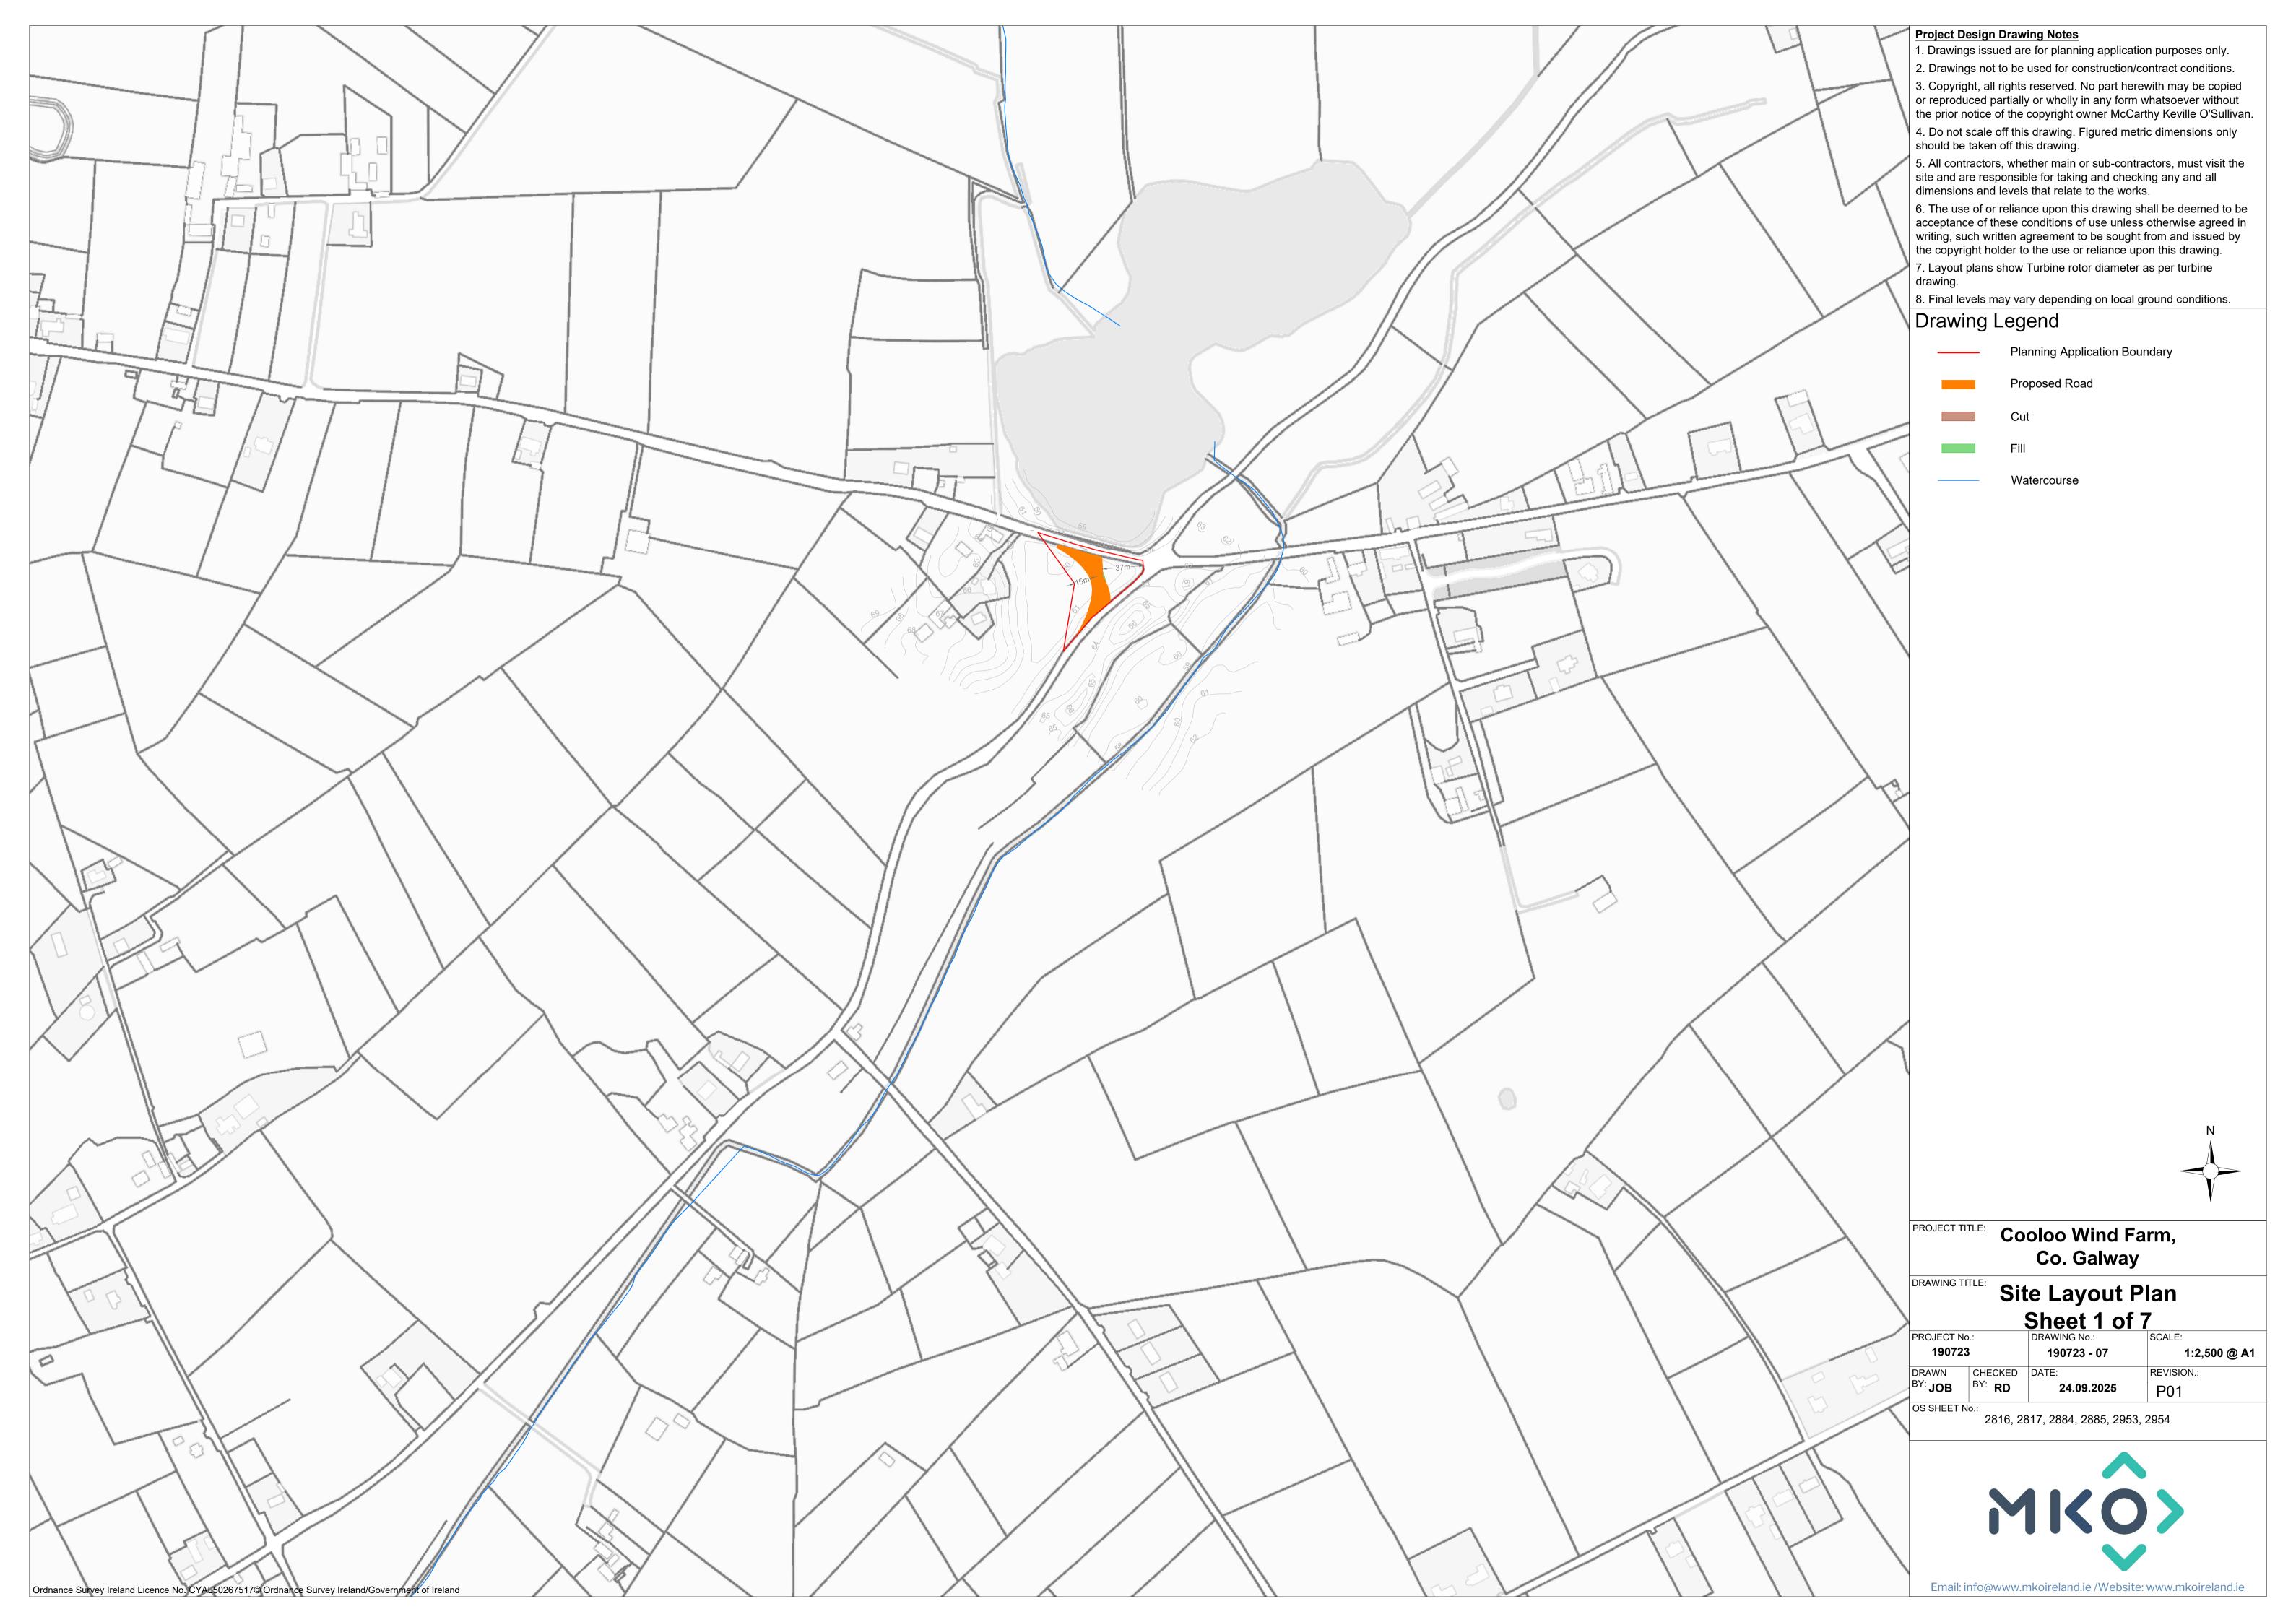





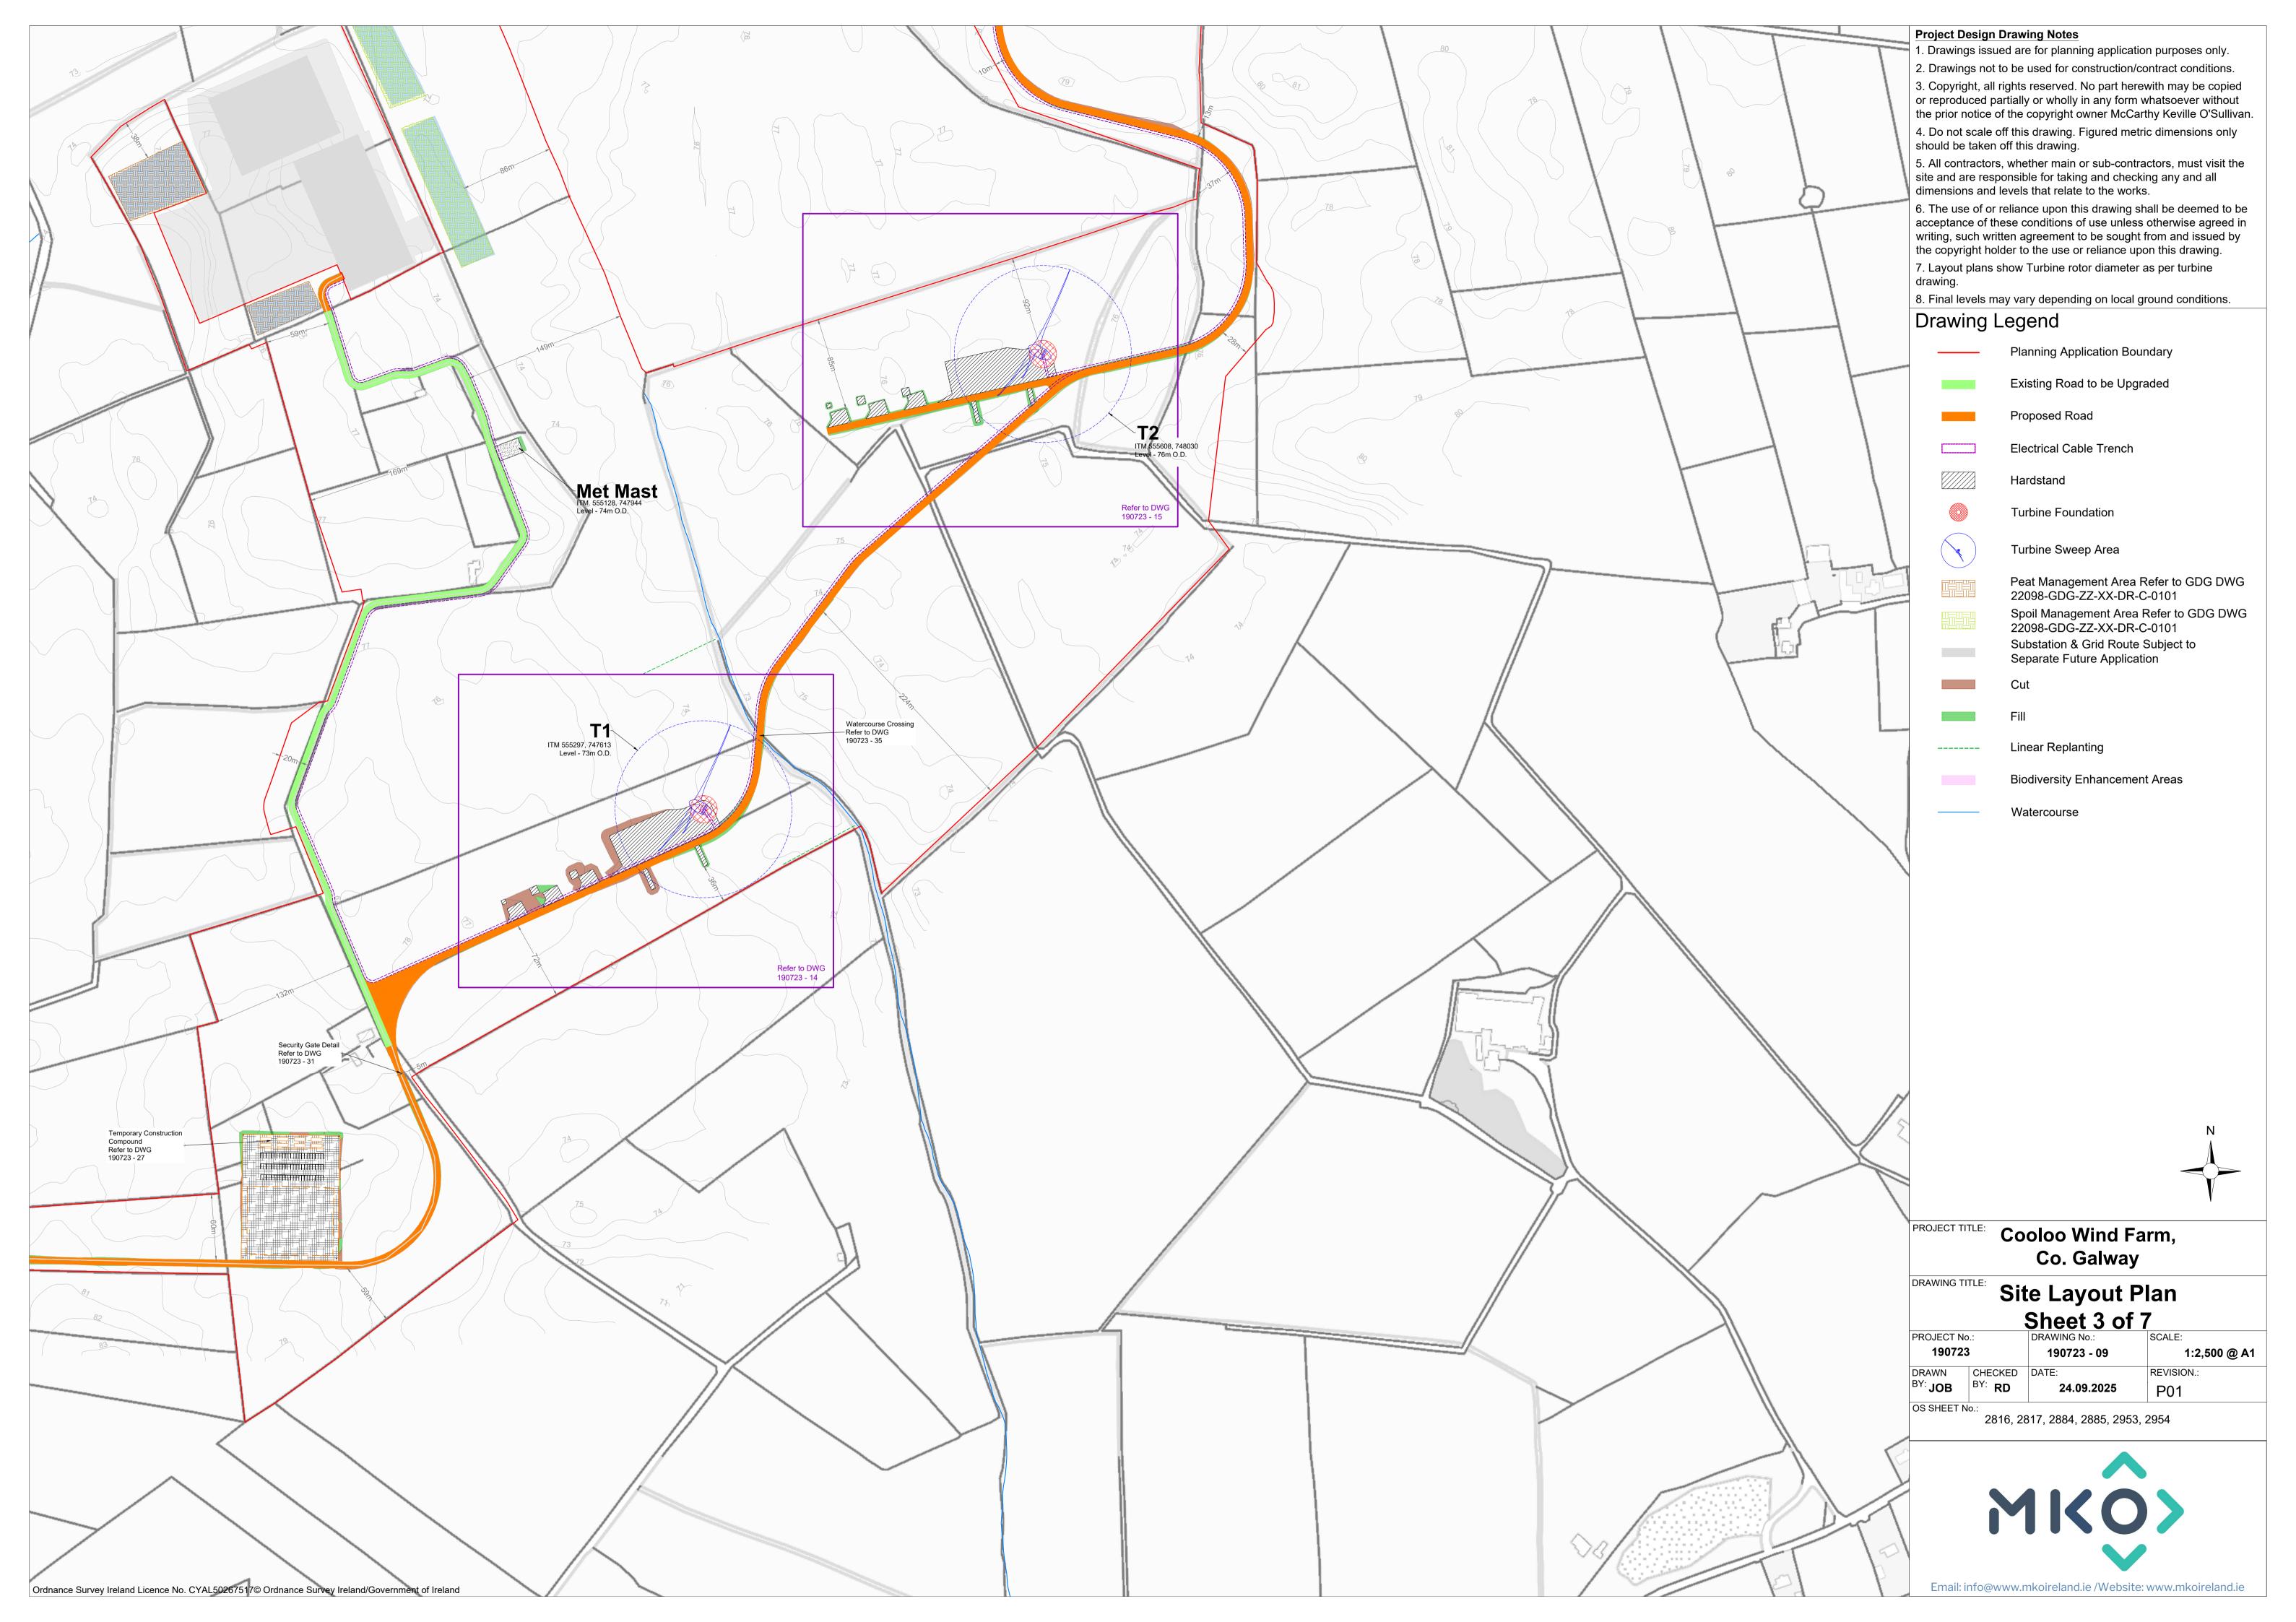

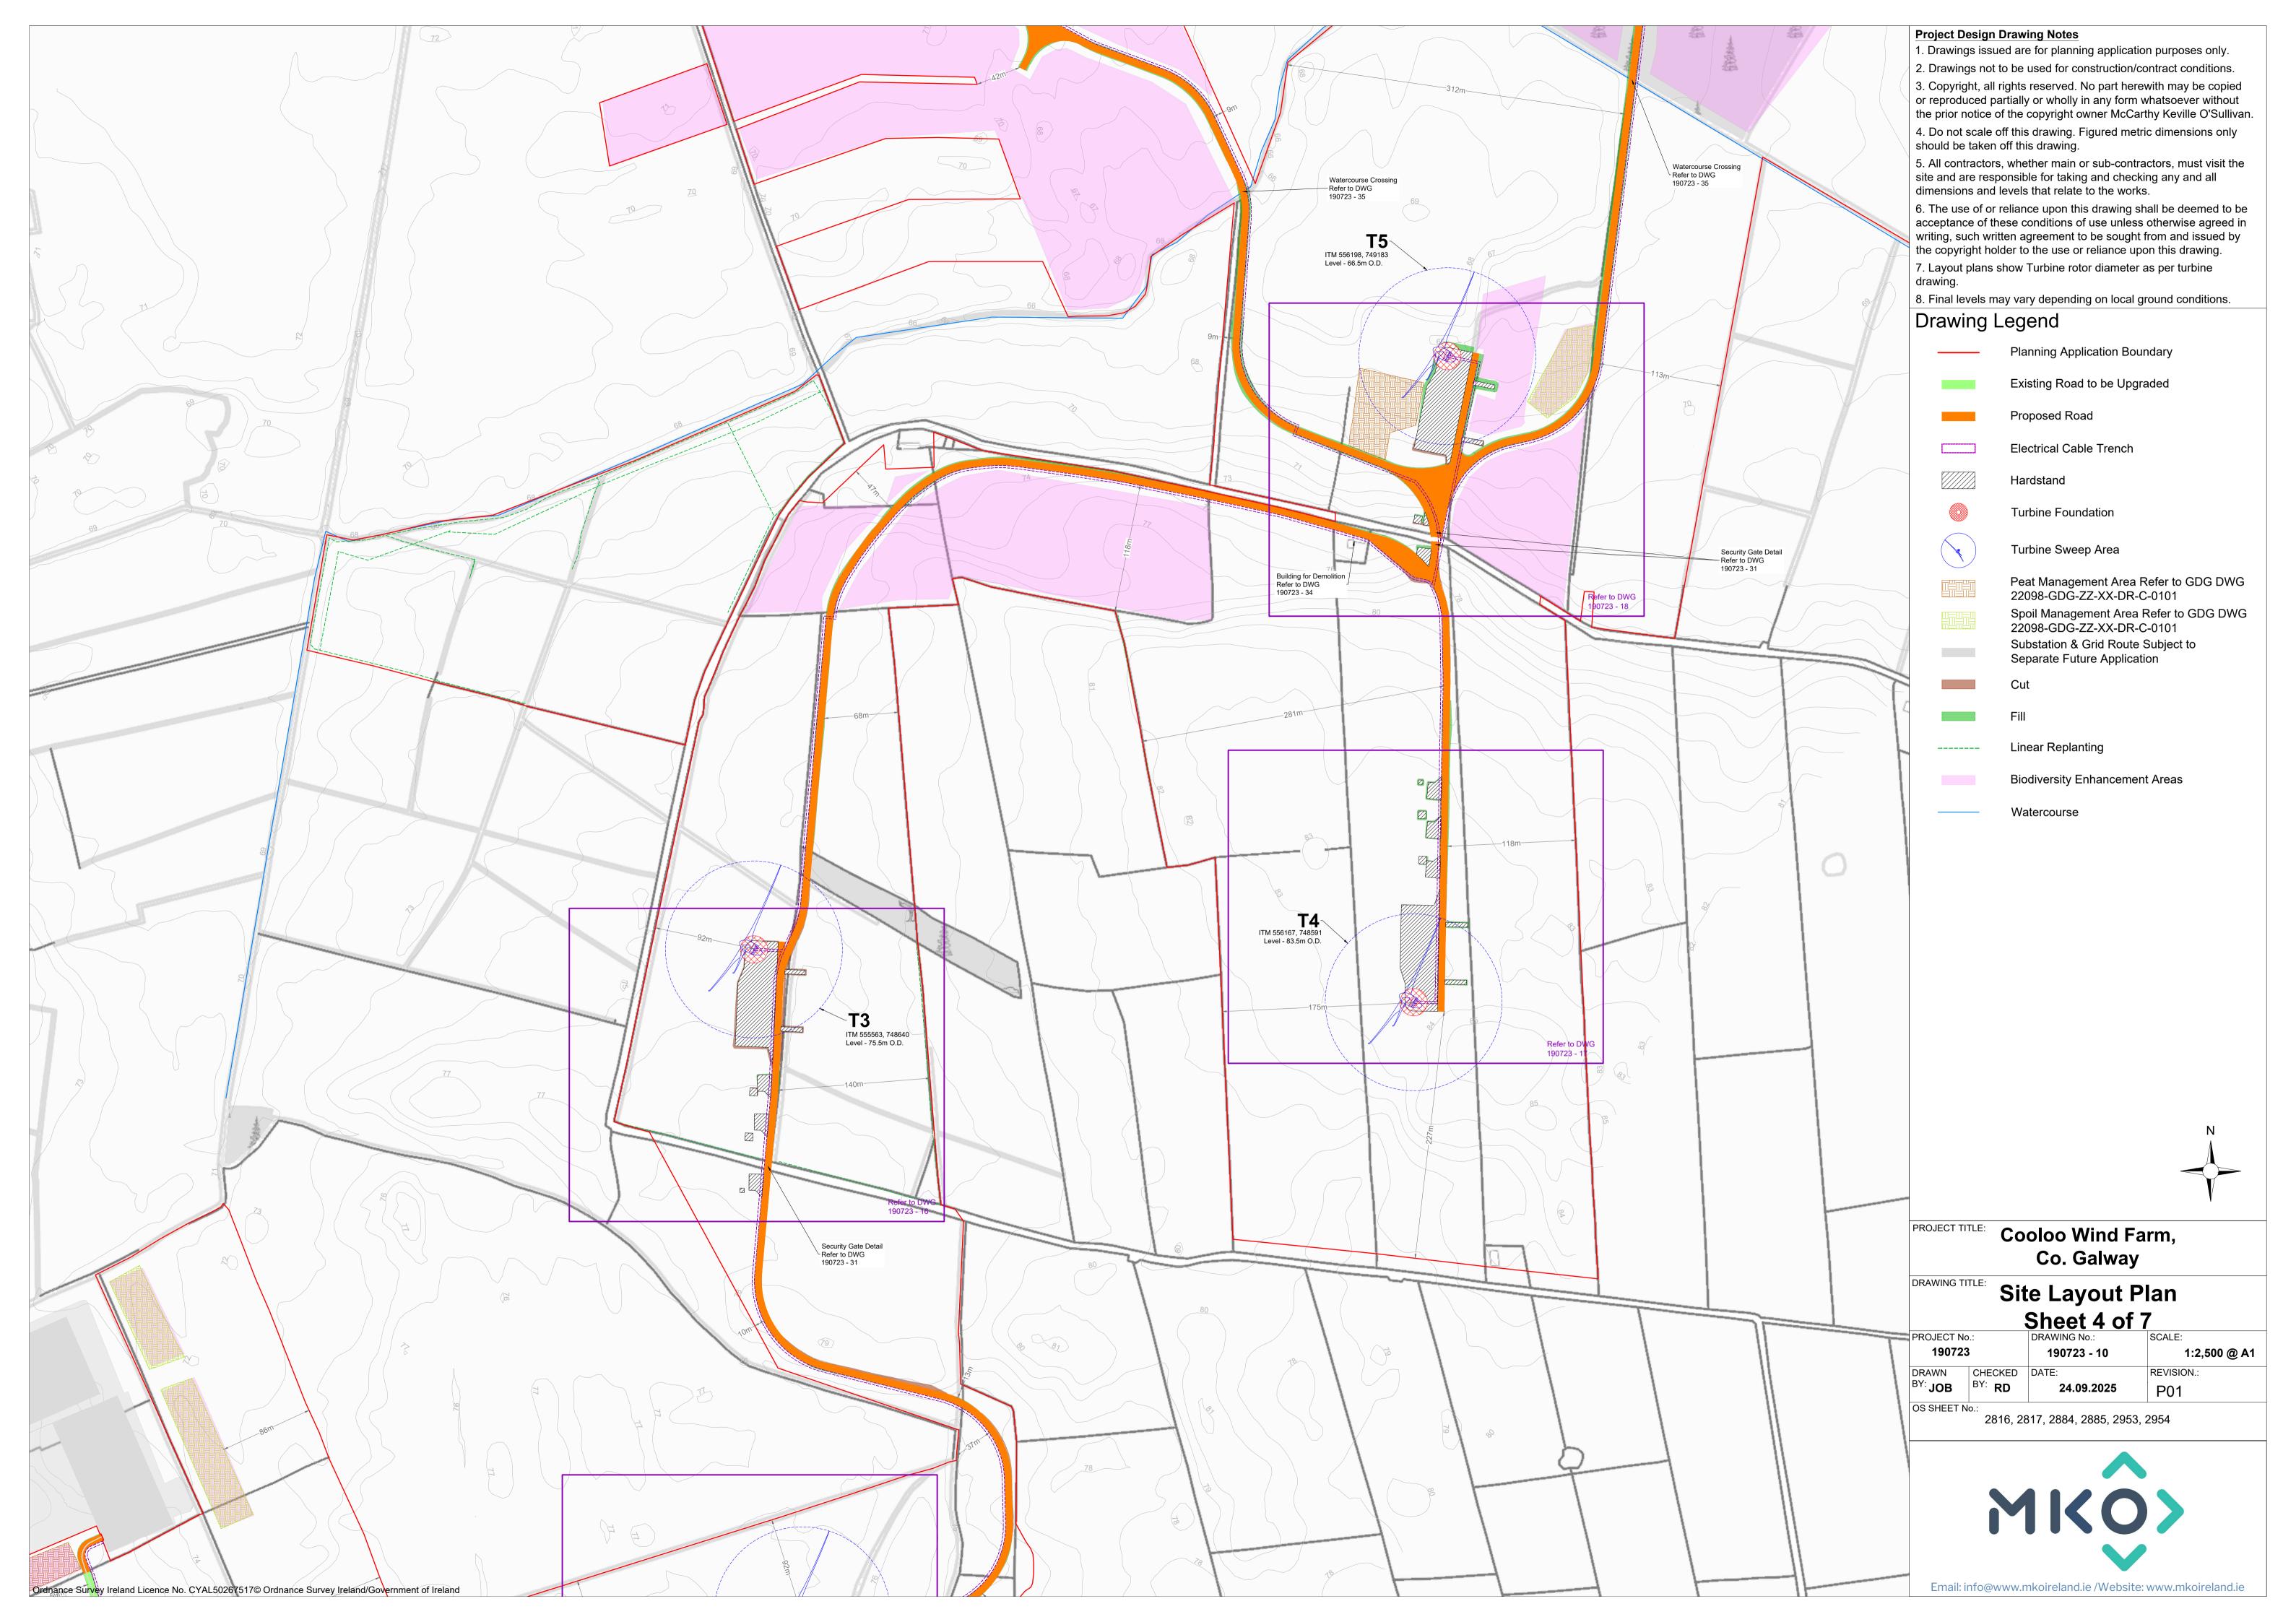


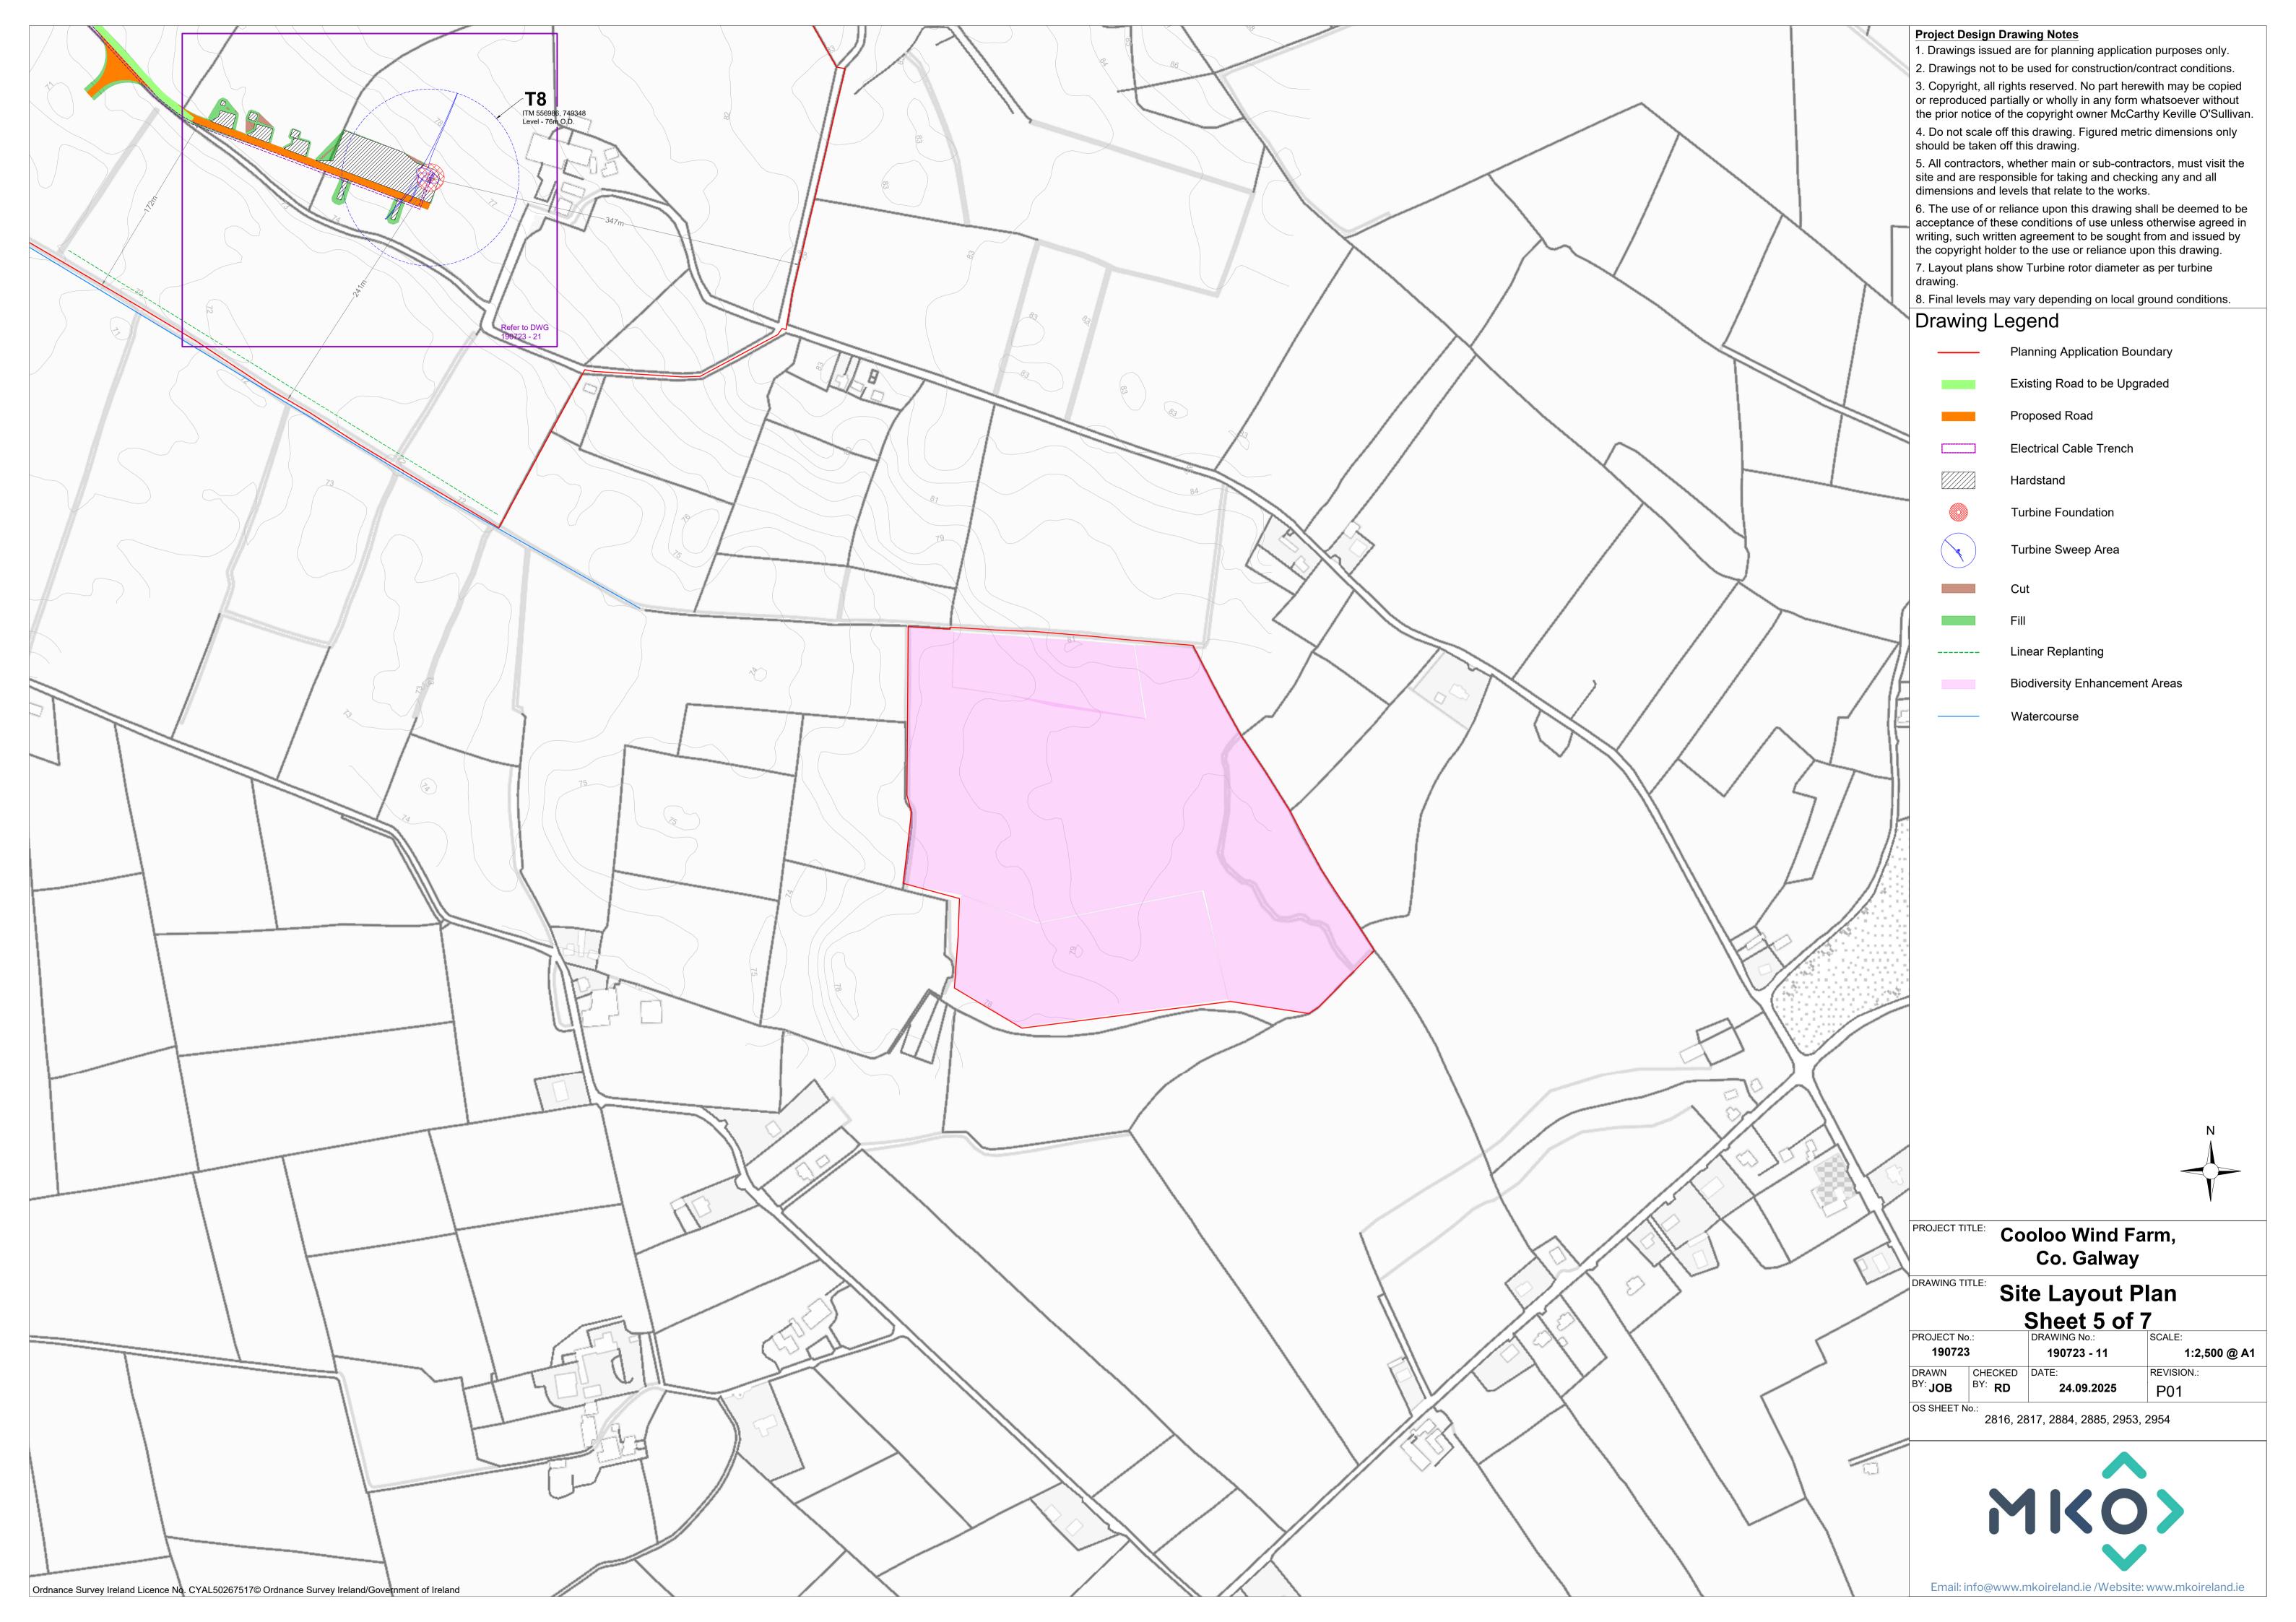

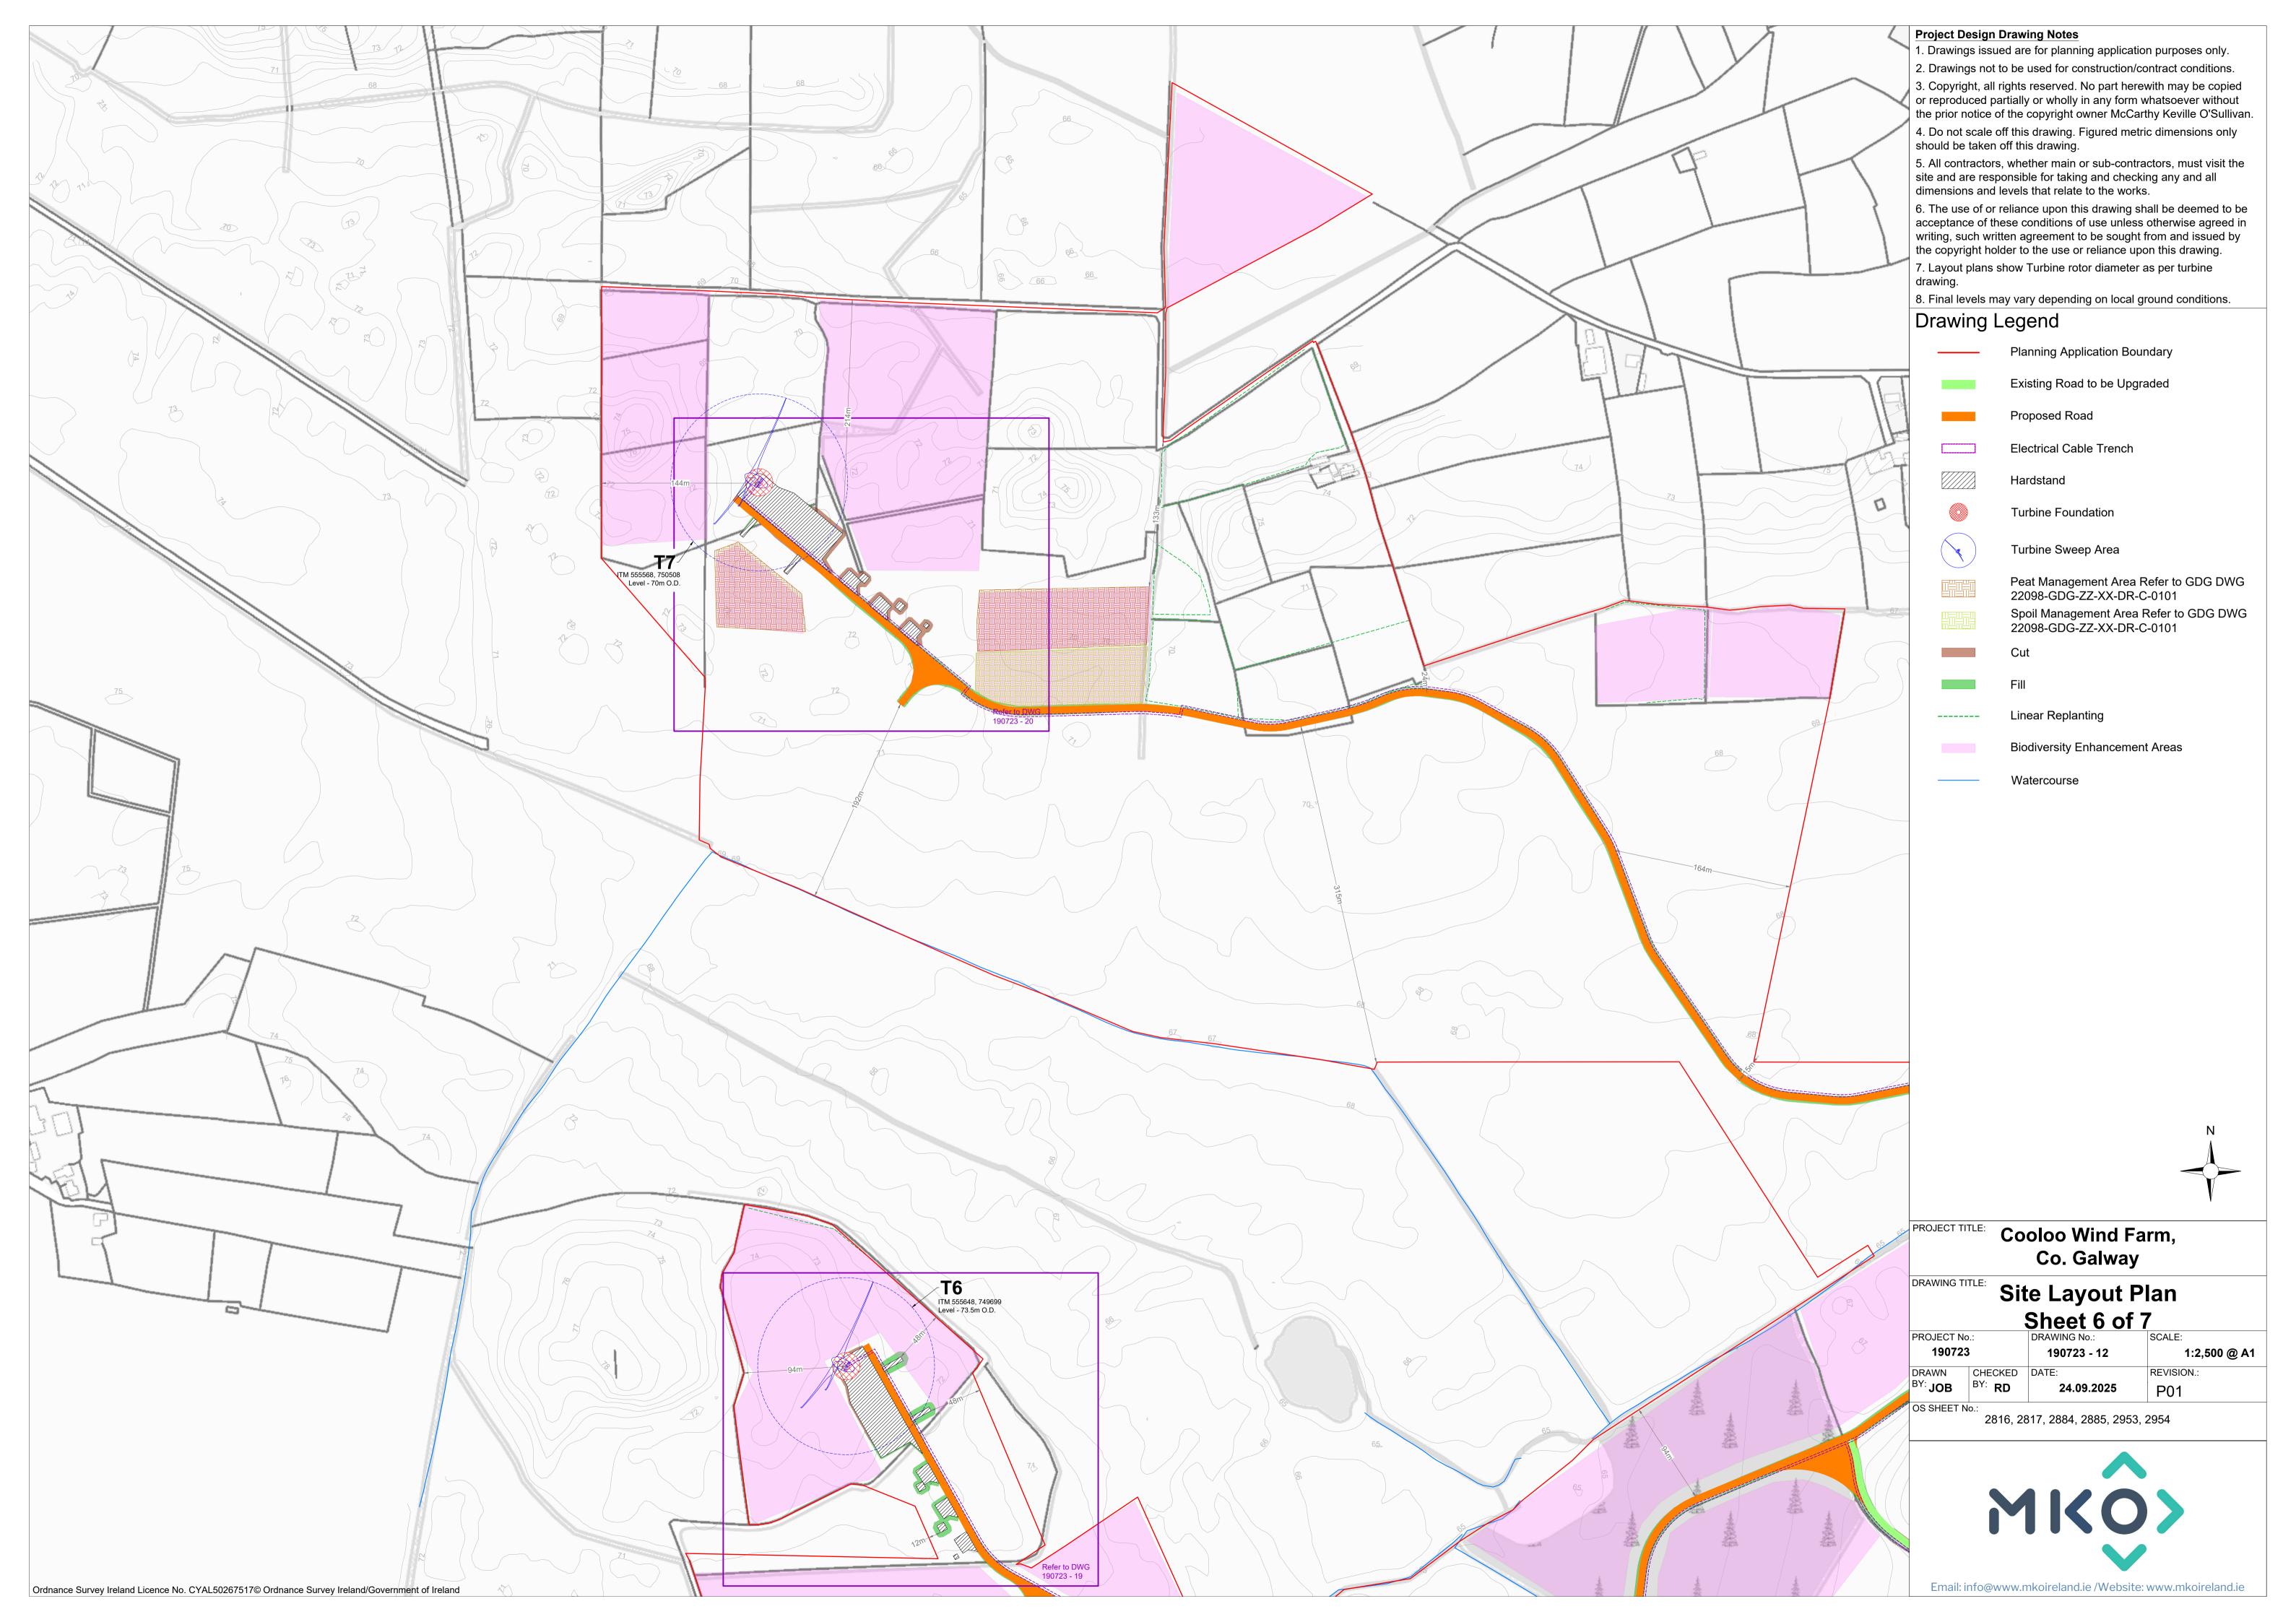

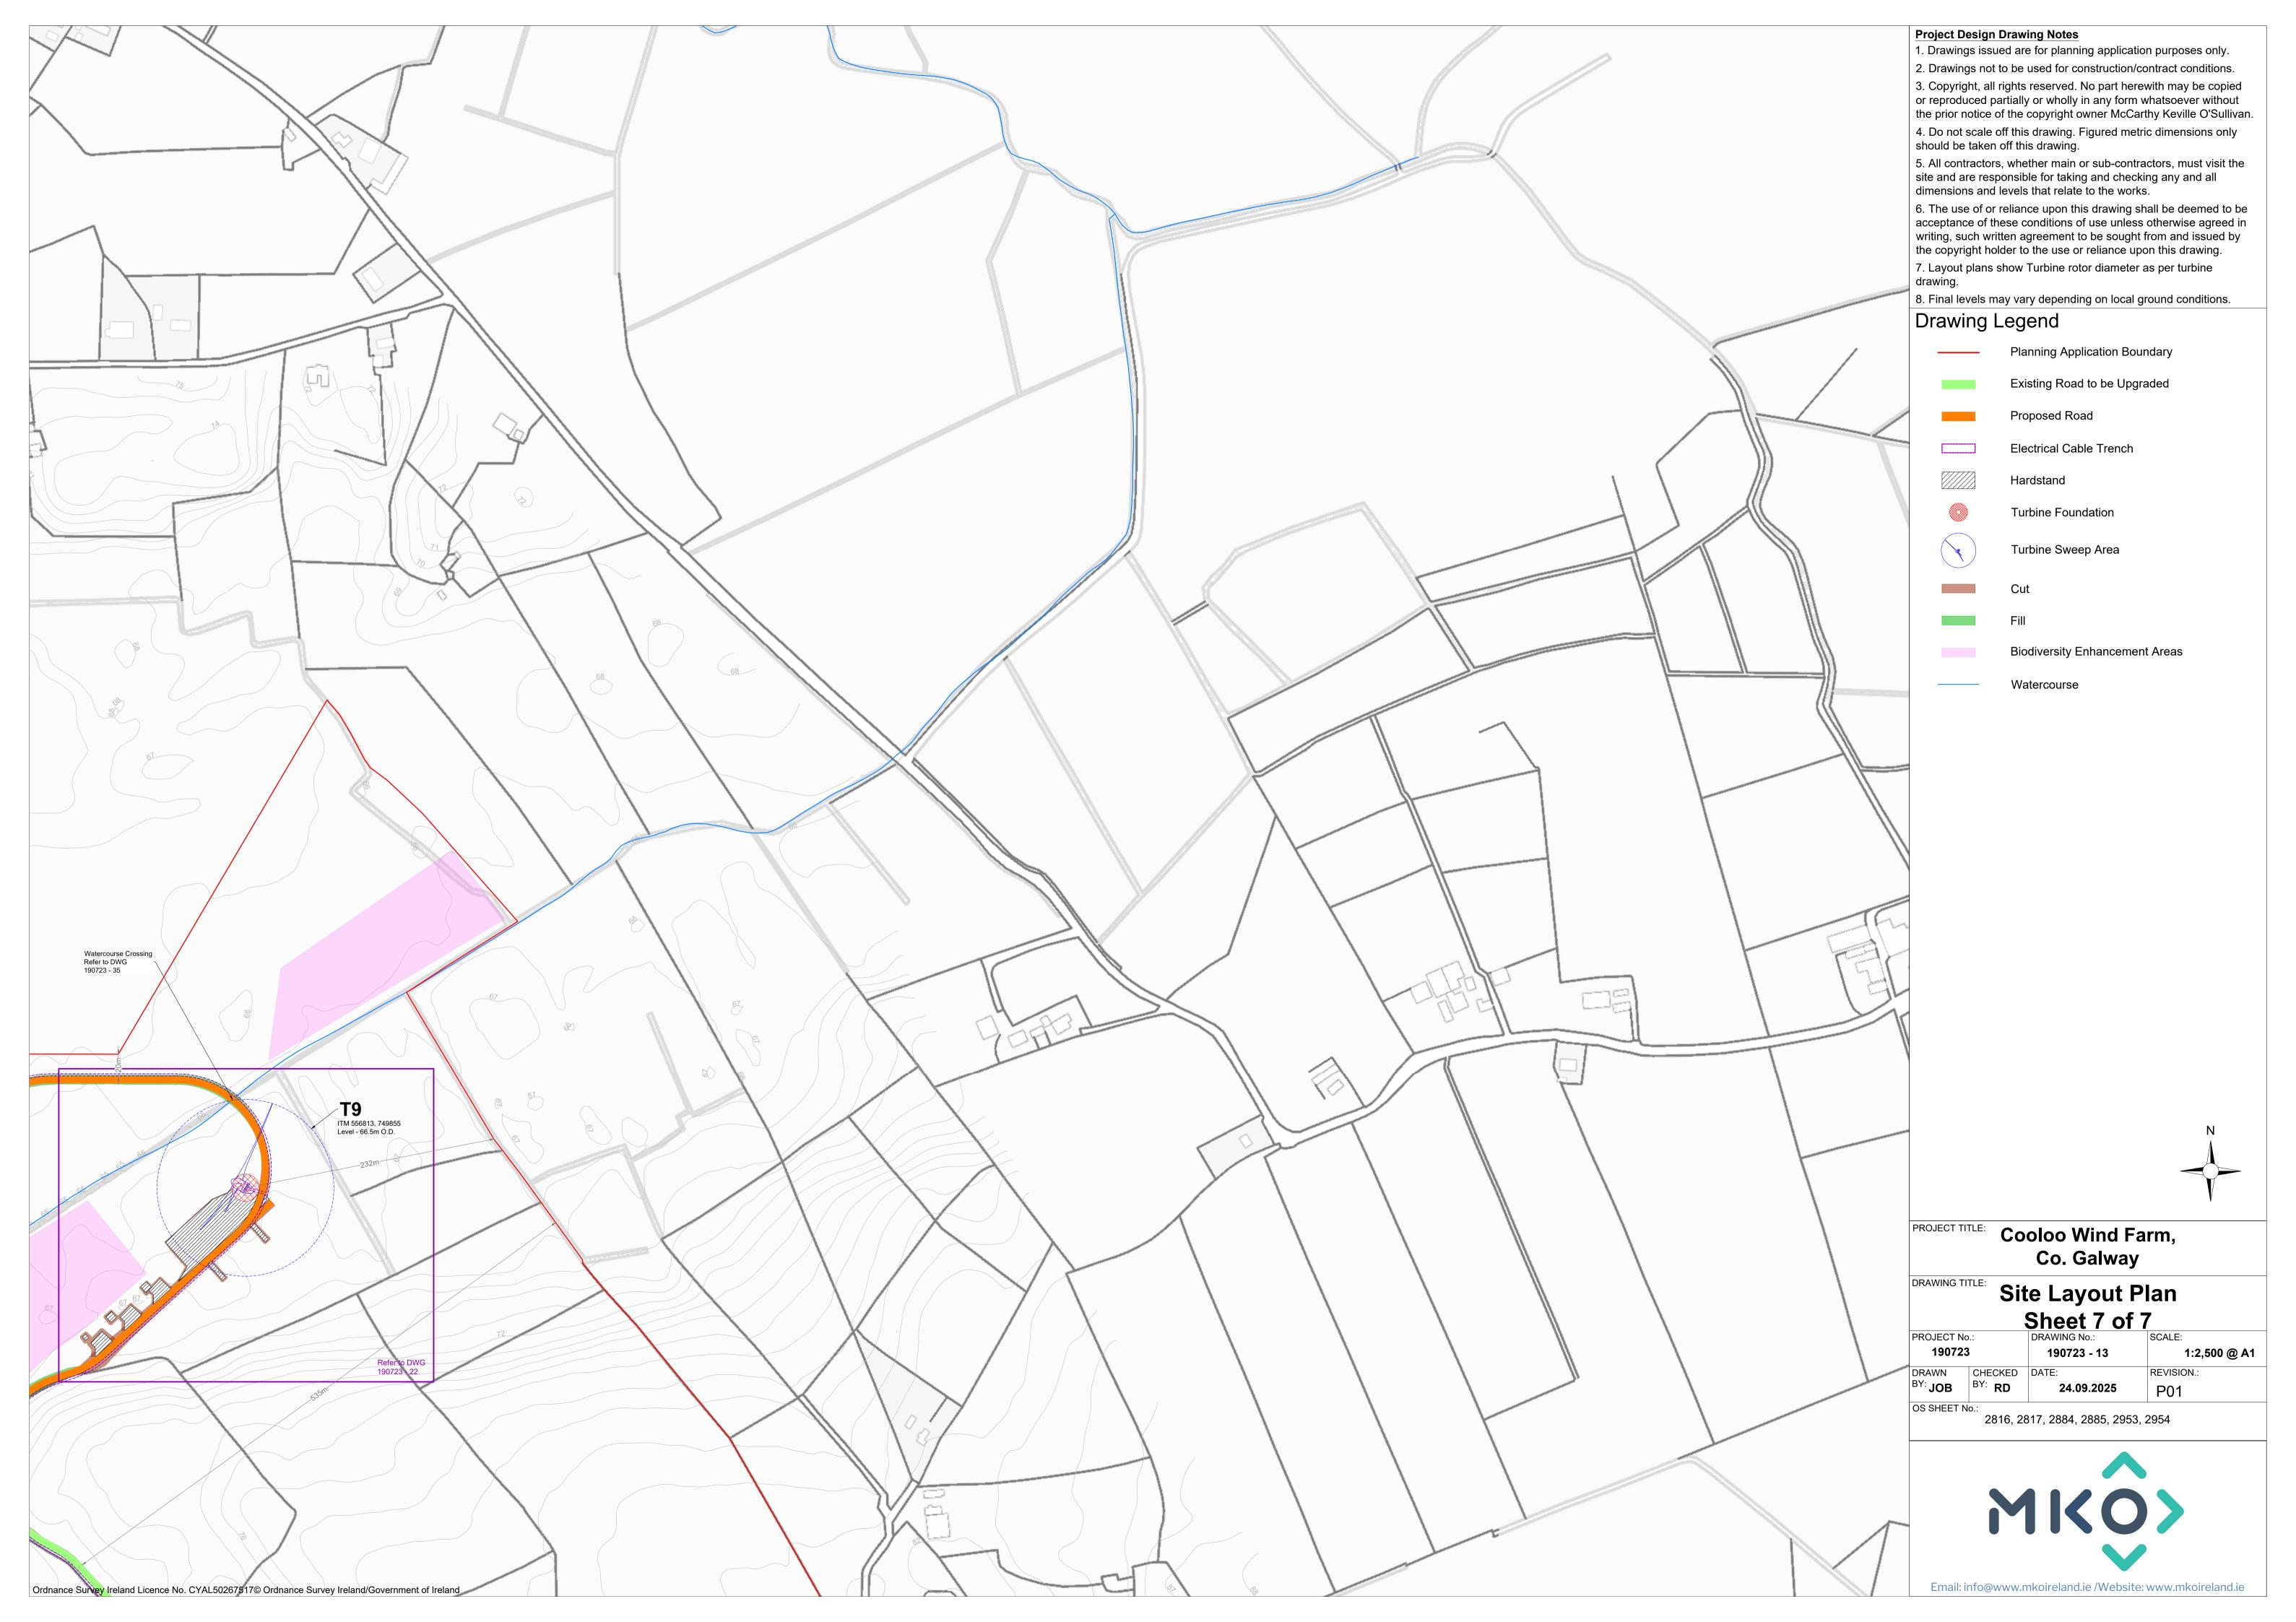



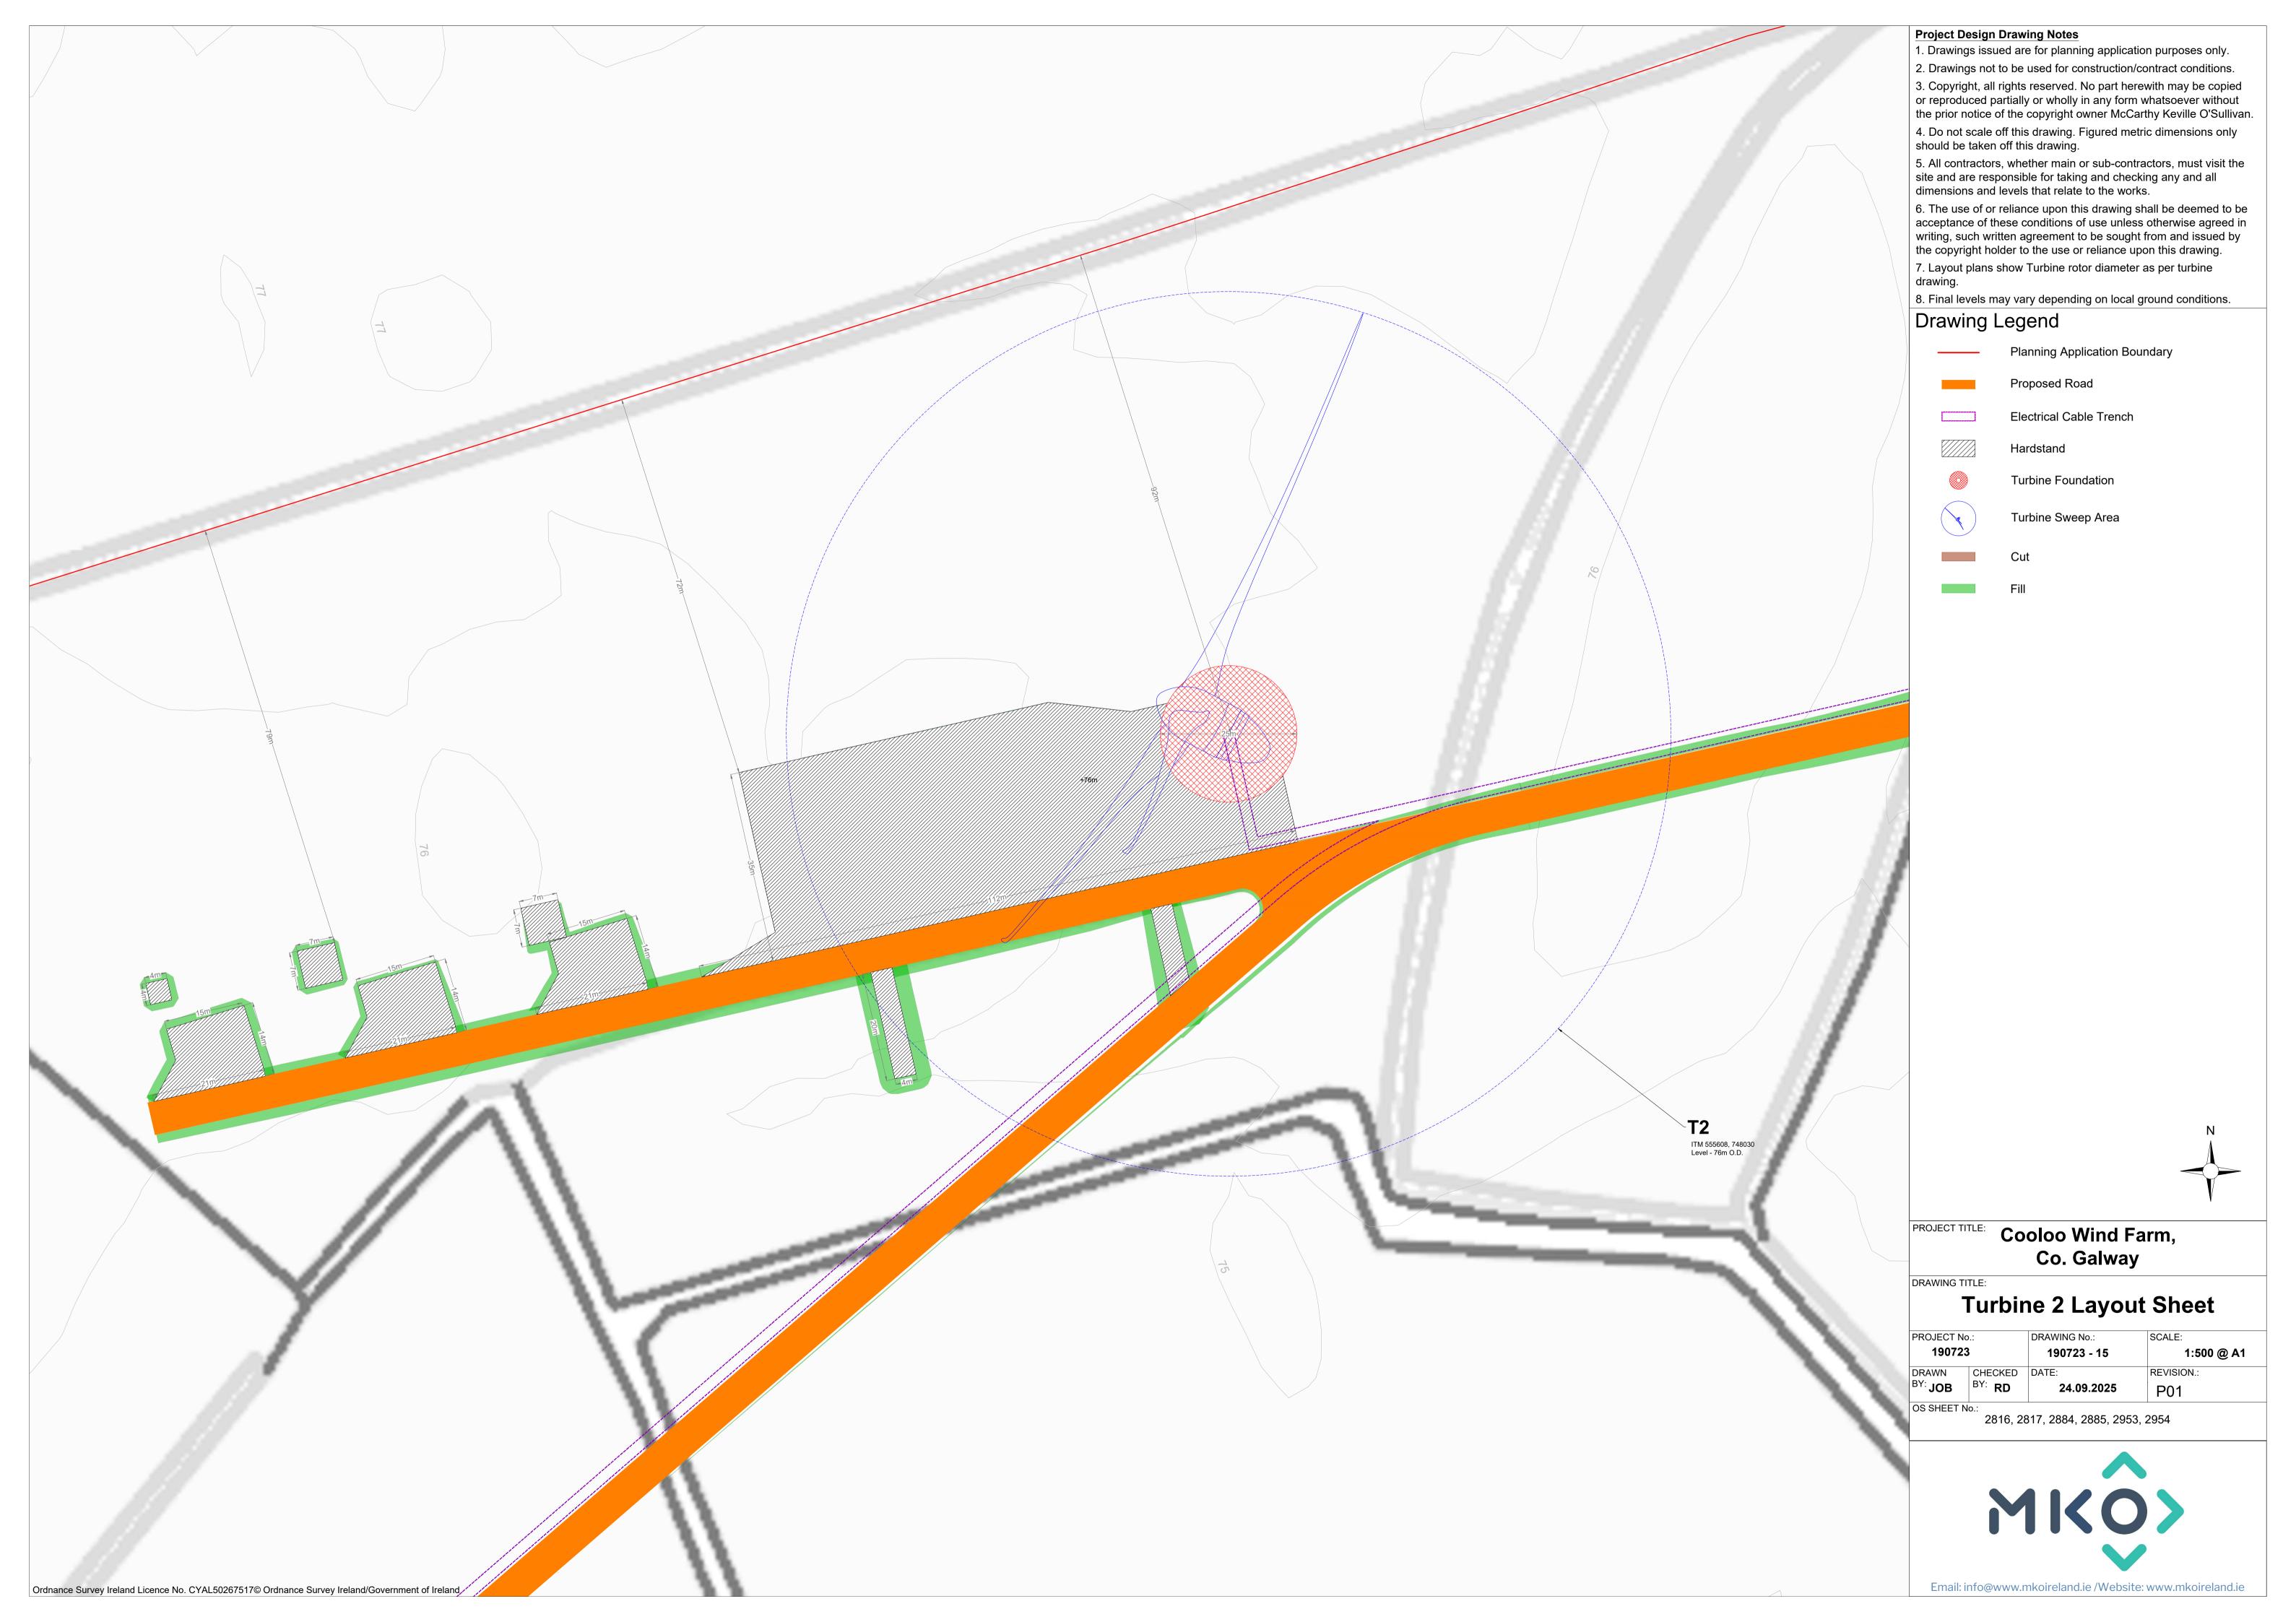





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8. Final levels may vary depending on local ground conditions.

Planning Application Boundary

Proposed Road

Hardstand

Turbine Sweep Area





Cooloo Wind Farm, Co. Galway

### **Turbine 4 Layout Sheet**

PROJECT No.:		DRAWING No.:	SCALE:
190723		190723 - 17	1:500 @ A1
DRAWN	CHECKED	DATE:	REVISION.:
BY: <b>JOB</b>	BY: RD	24.09.2025	P01

2816, 2817, 2884, 2885, 2953, 2954



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#### 8. Final levels may vary depending on local ground conditions.



Planning Application Boundary

Proposed Road

Electrical Cable Trench

Hardstand



**Turbine Foundation** 

Turbine Sweep Area





Peat Management Area Refer to GDG DWG 22098-GDG-ZZ-XX-DR-C-0101 Spoil Management Area Refer to GDG DWG 22098-GDG-ZZ-XX-DR-C-0101





Biodiversity Enhancement Areas

Cooloo Wind Farm,

Co. Galway


### **Turbine 5 Layout Sheet**

PROJECT No.:		DRAWING No.:	SCALE:
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DRAWN	CHECKED	DATE:	REVISION.:
BY: <b>JOB</b>	BY: RD	24.09.2025	P01


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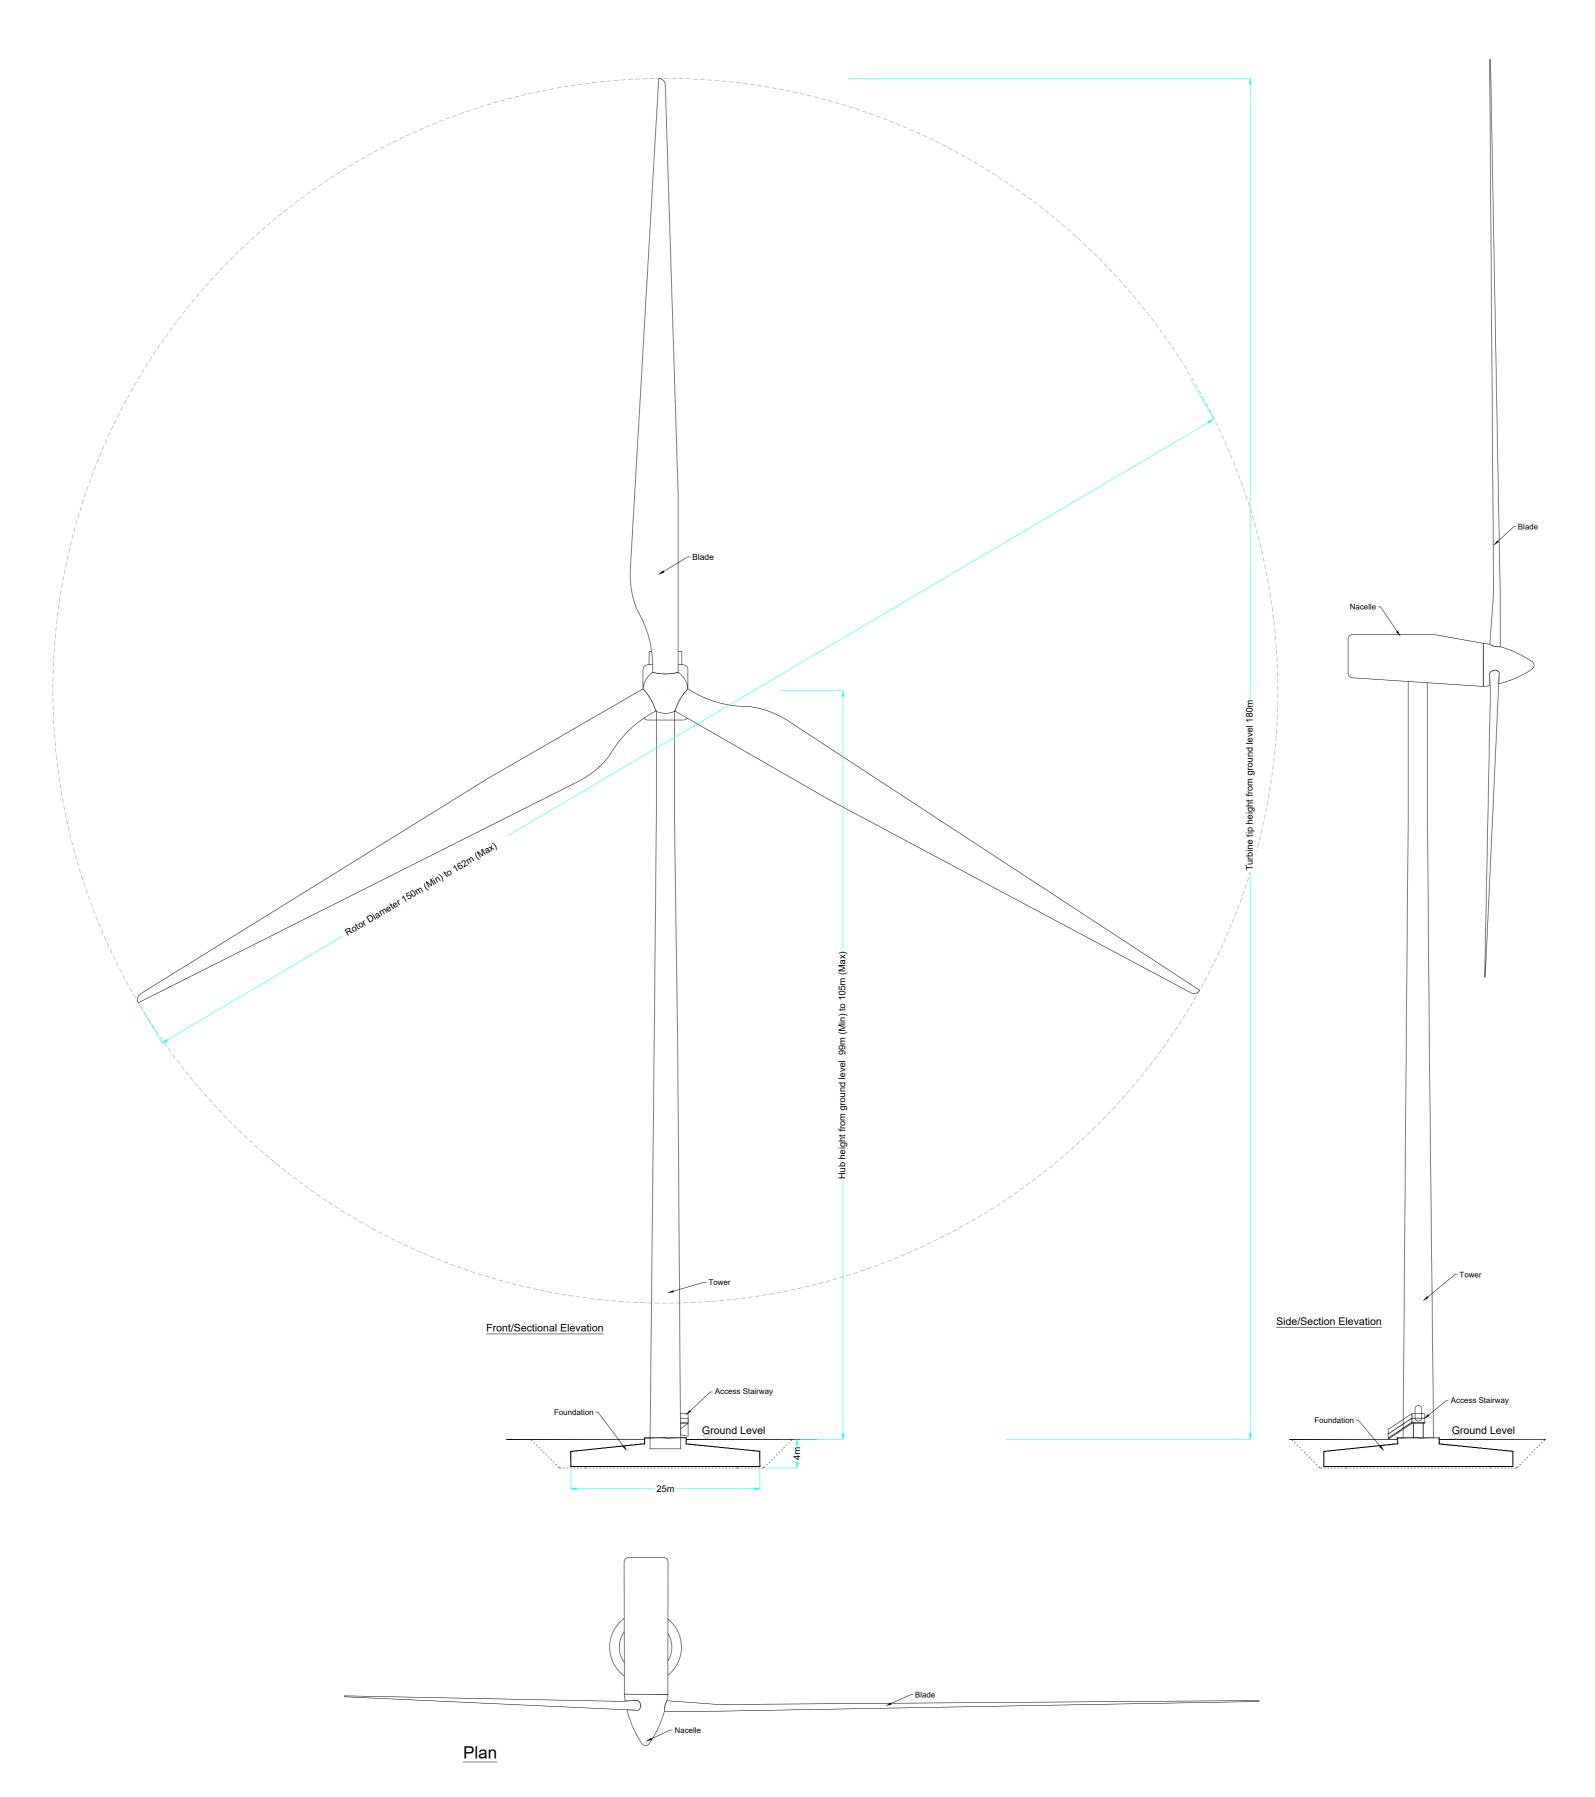






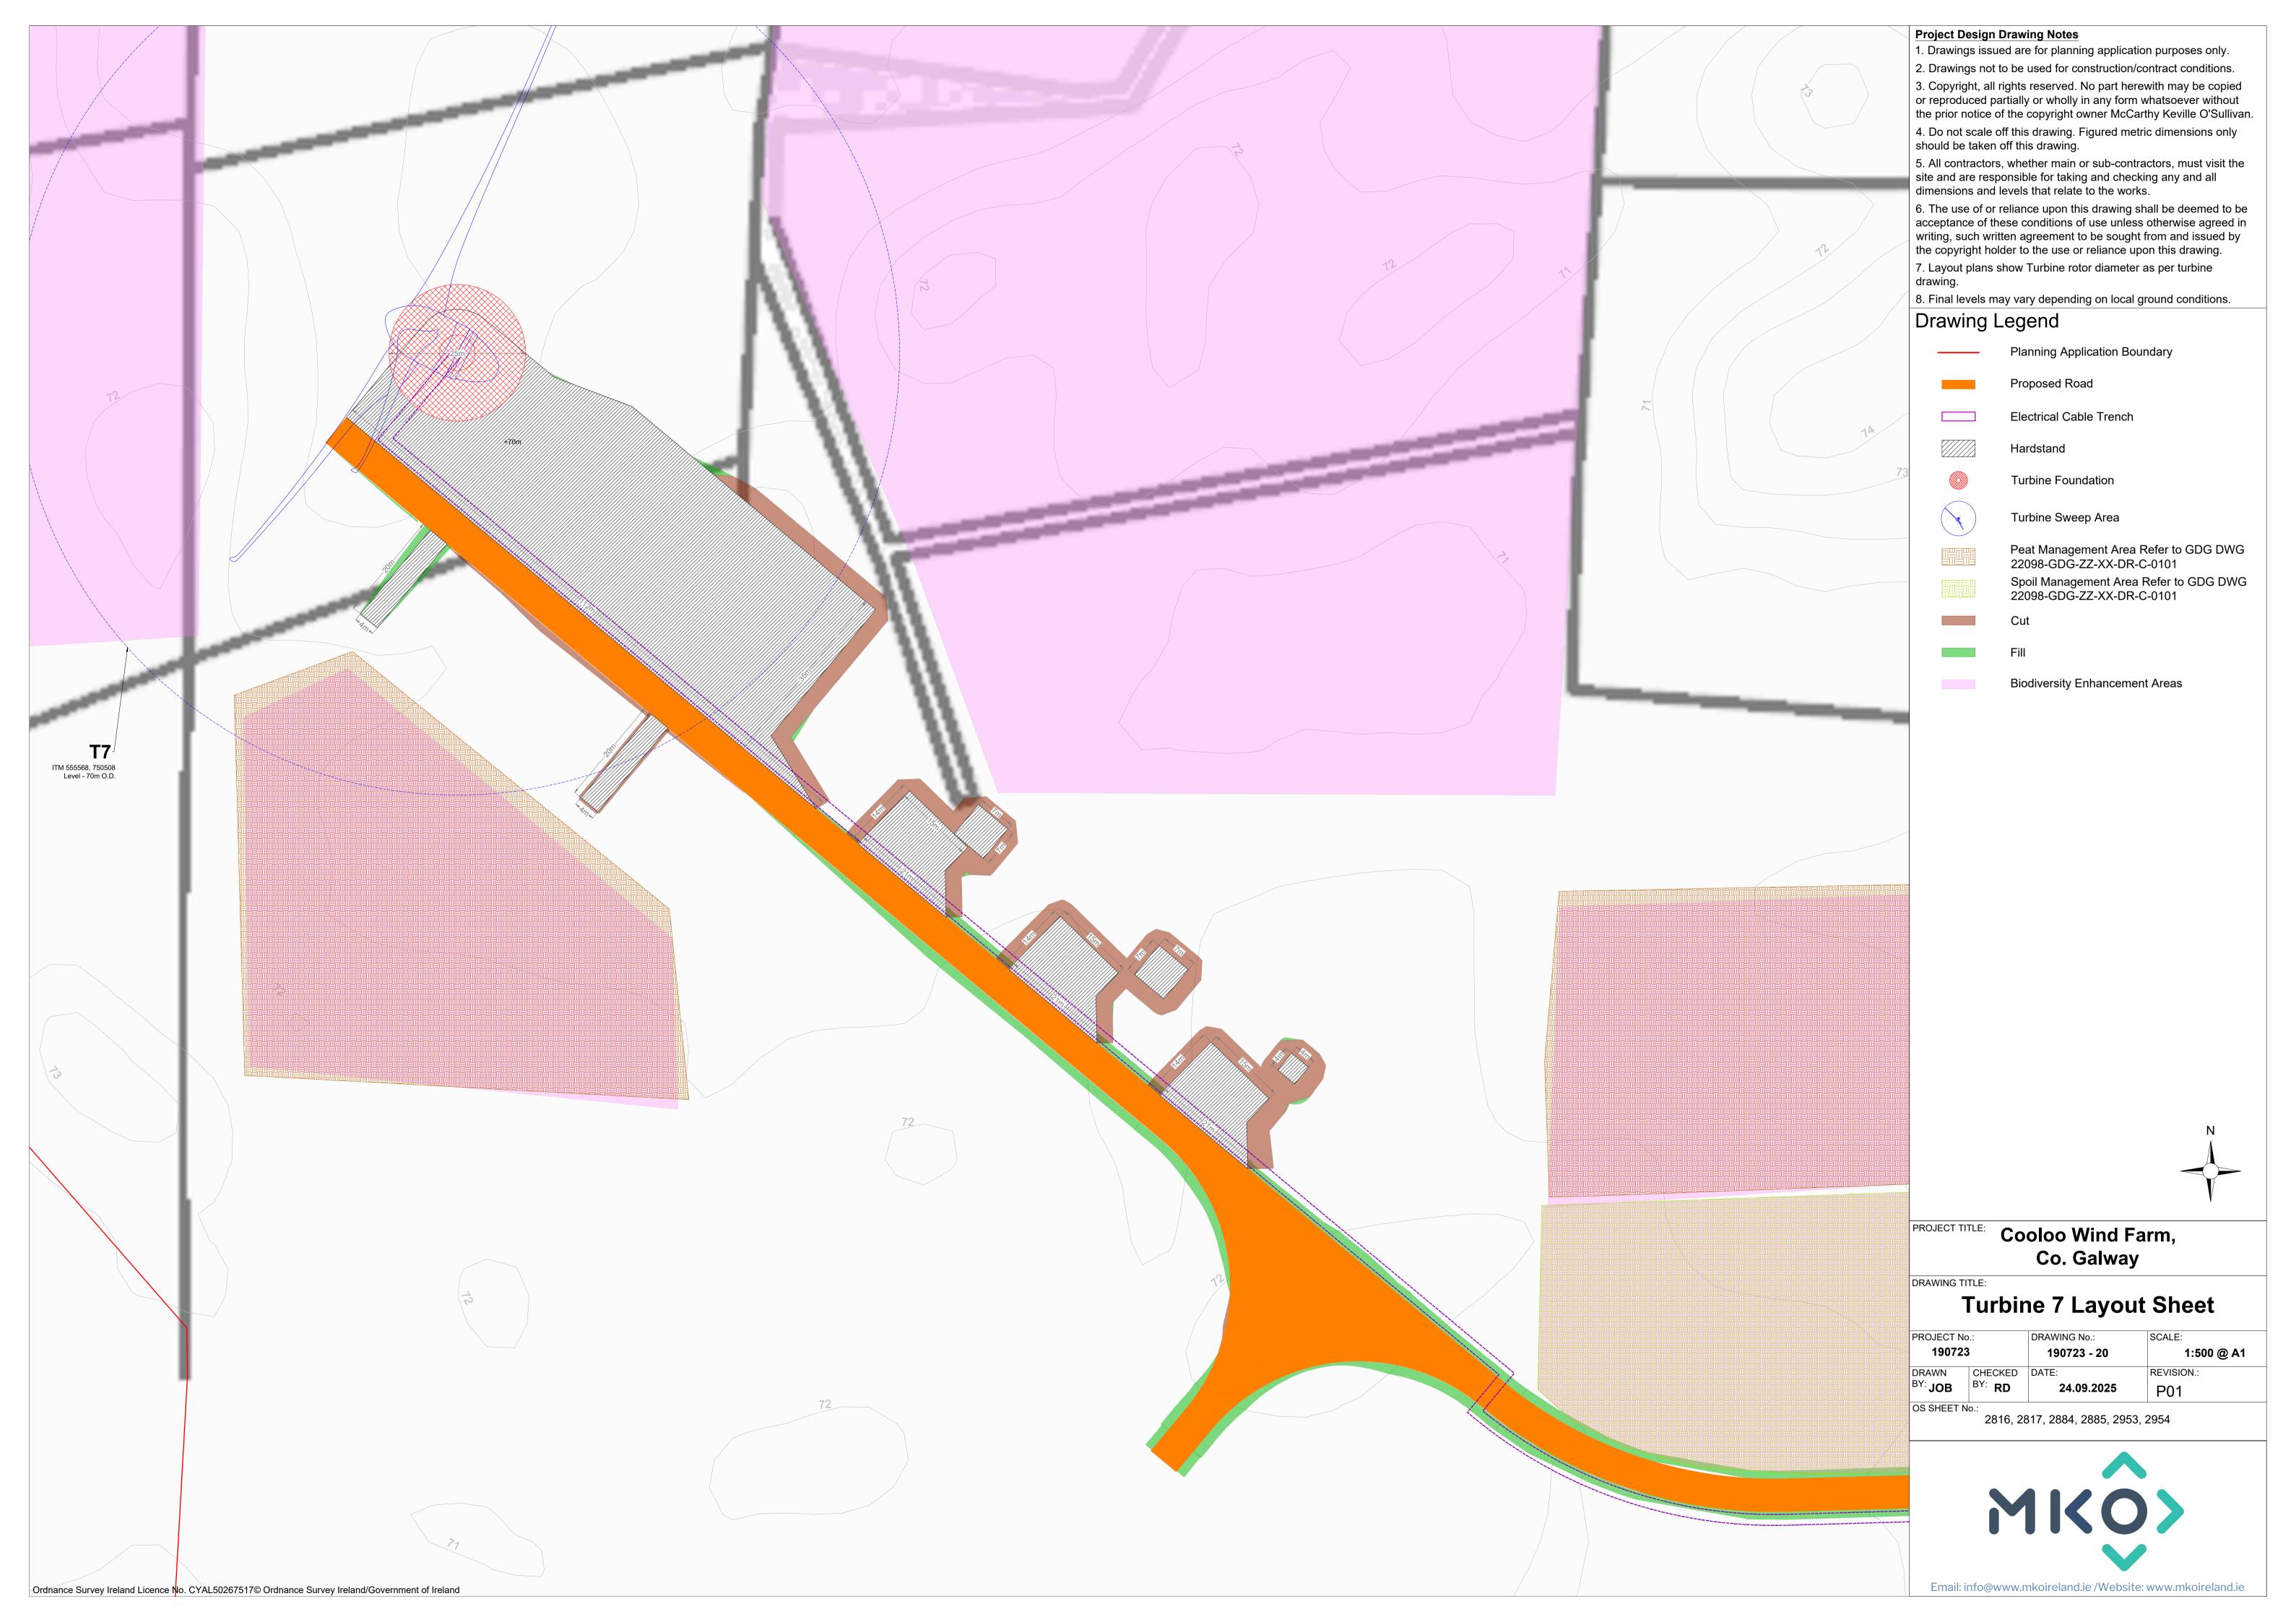

1:500 @ A1

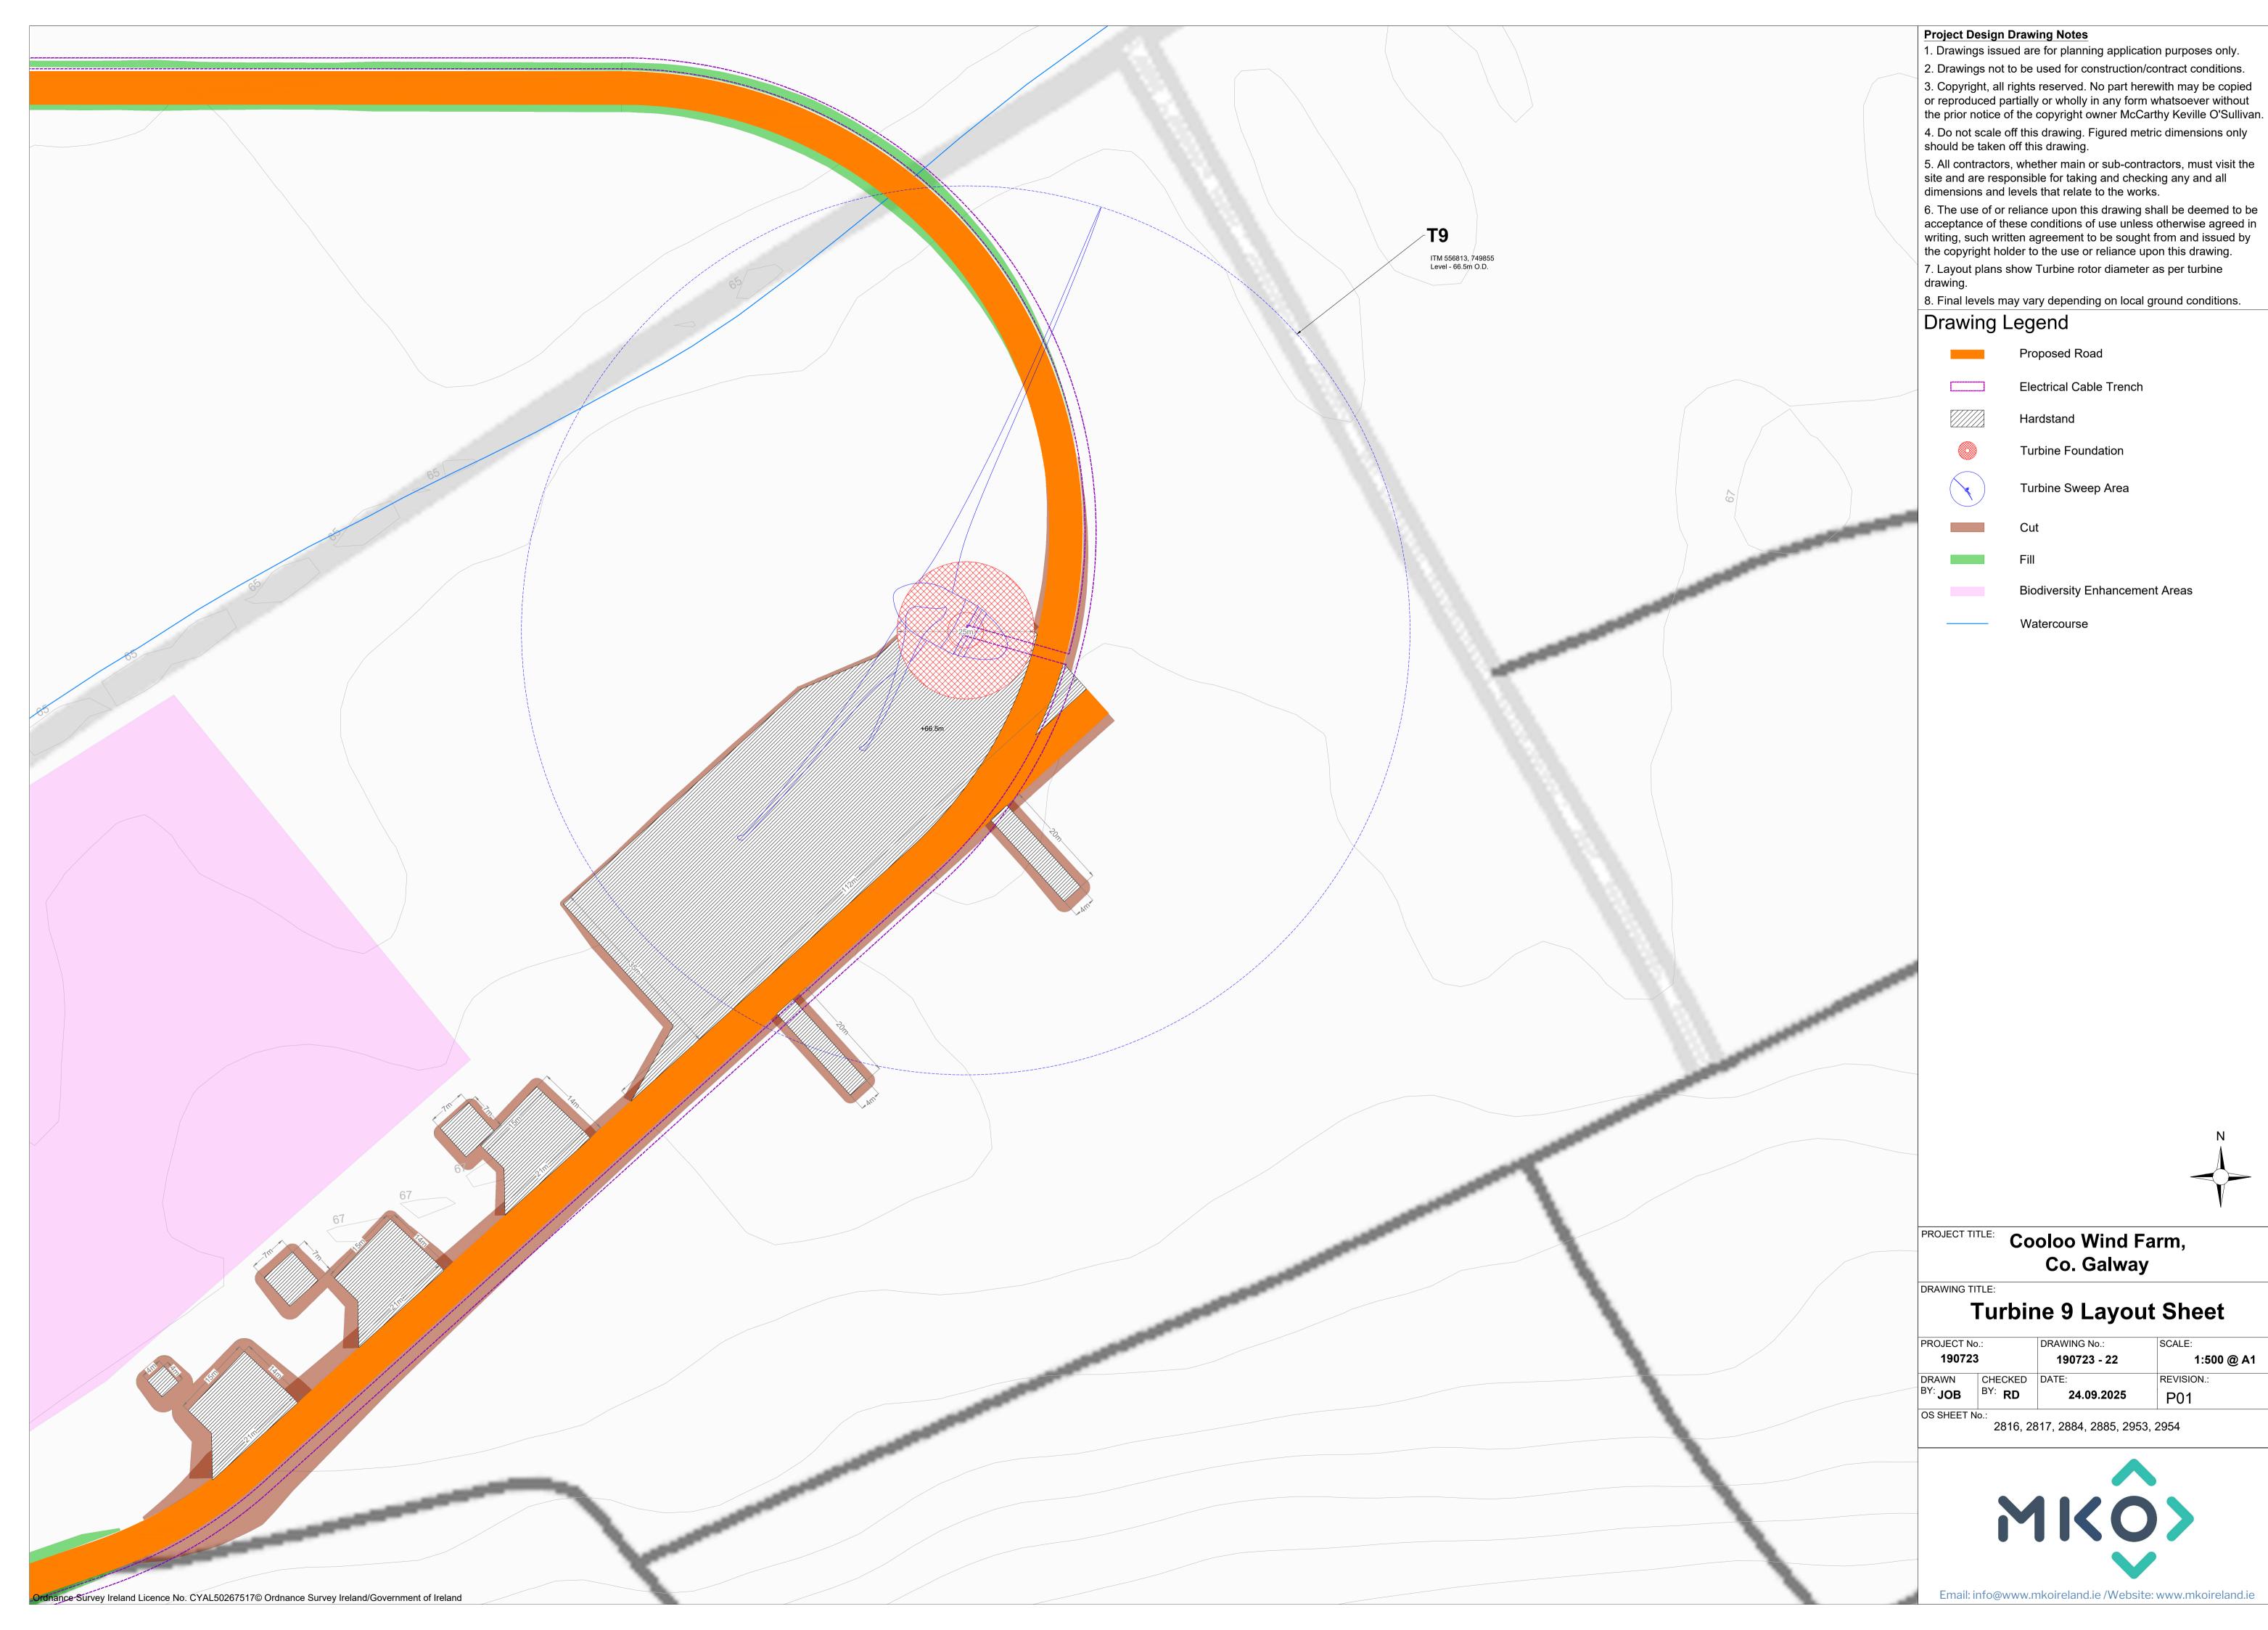

# PROJECT TITLE: Cooloo Wind Farm, Co. Galway

Wind Turbine
Elevation & Plan

 PROJECT No.:
 DRAWING No.:
 SCALE:

 231103
 190723 - 23
 1:500 @ A1


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 CHECKED BY: RD
 DATE: PO1


 BY: JOB
 24.09.2025
 P01

#### Drawing Notes


- Proposed wind turbines to have a maximum ground to blade tip height of 180m, rotor diameter of 150m - 162m and hub height of 99m - 105m
- 2. Ground level represents the top of turbine foundation.




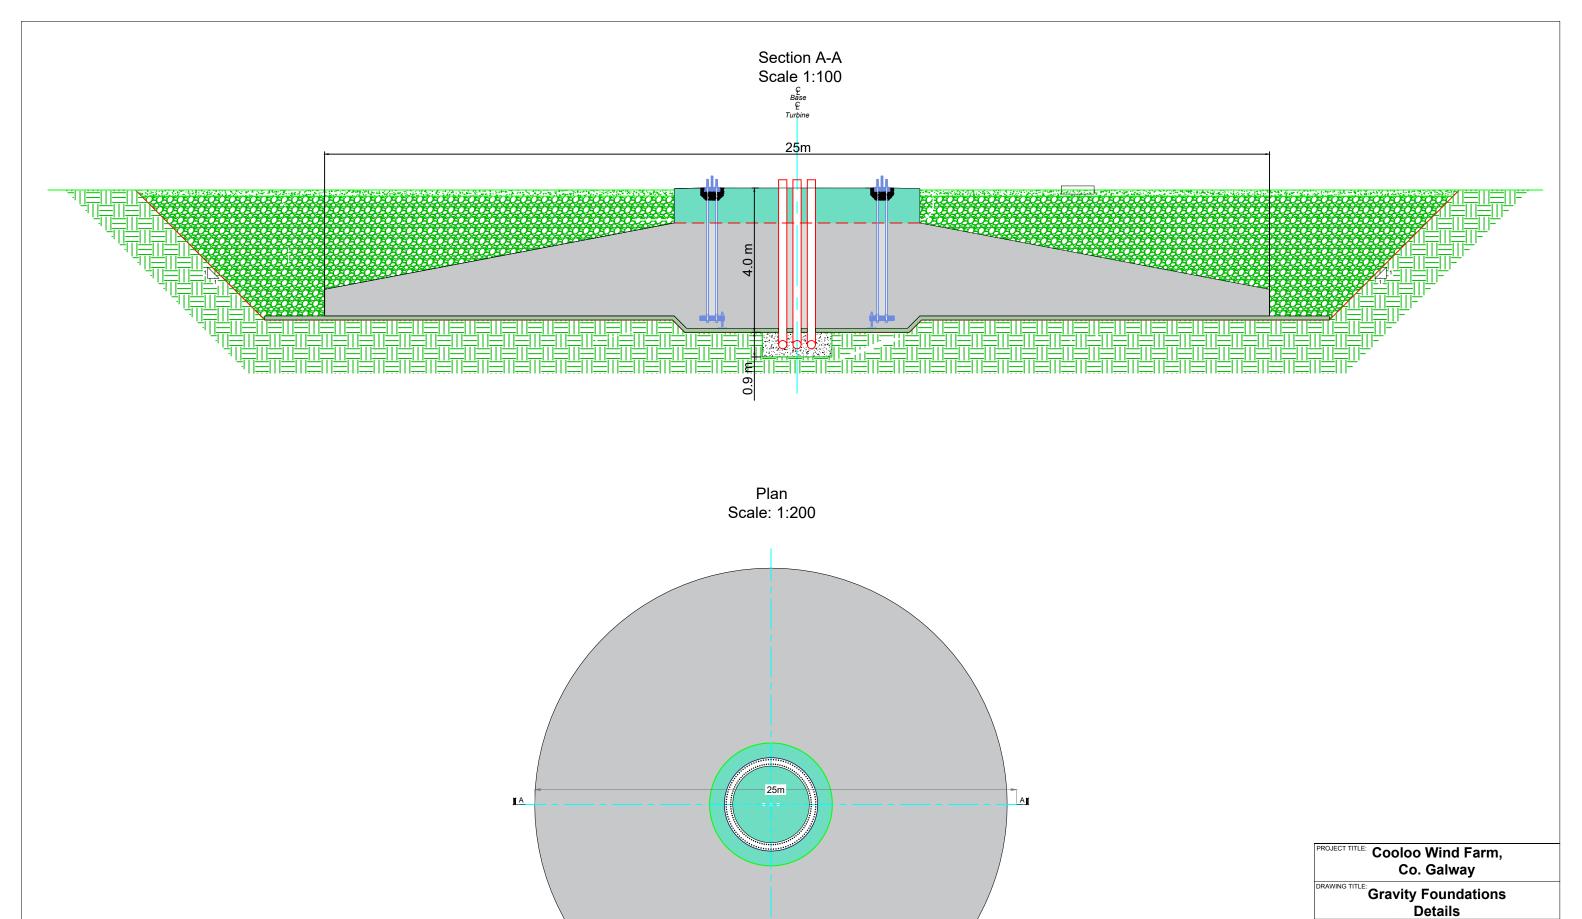


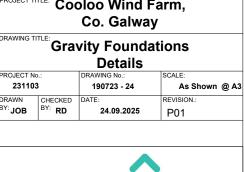



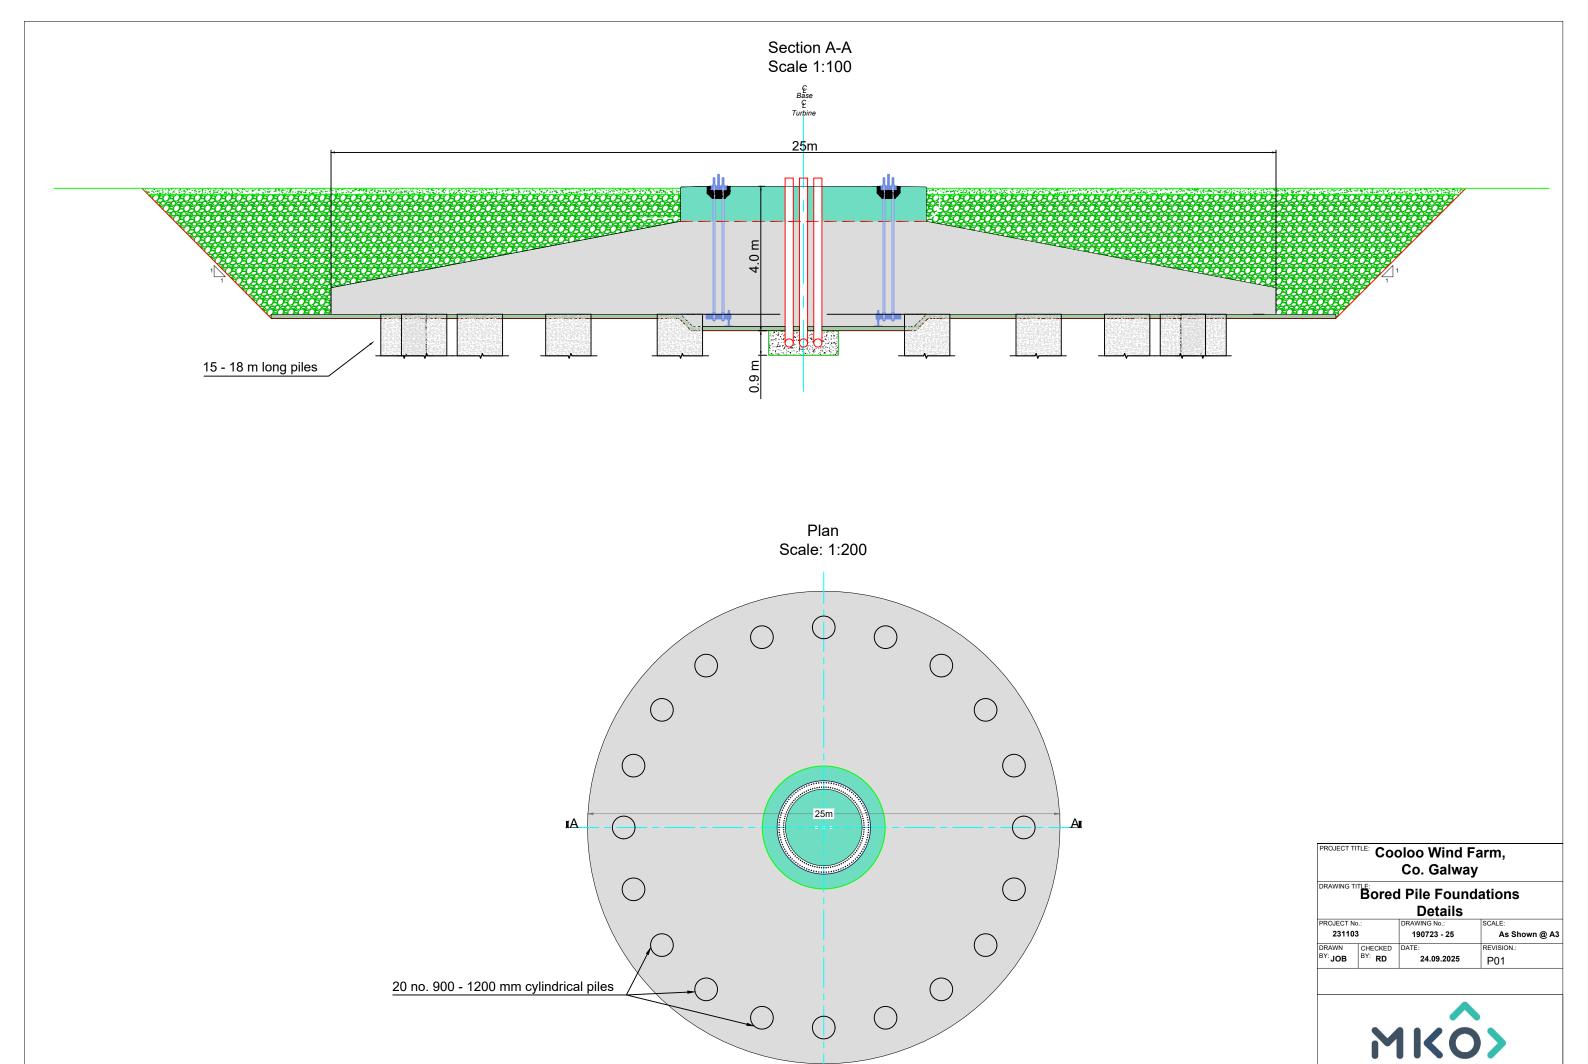

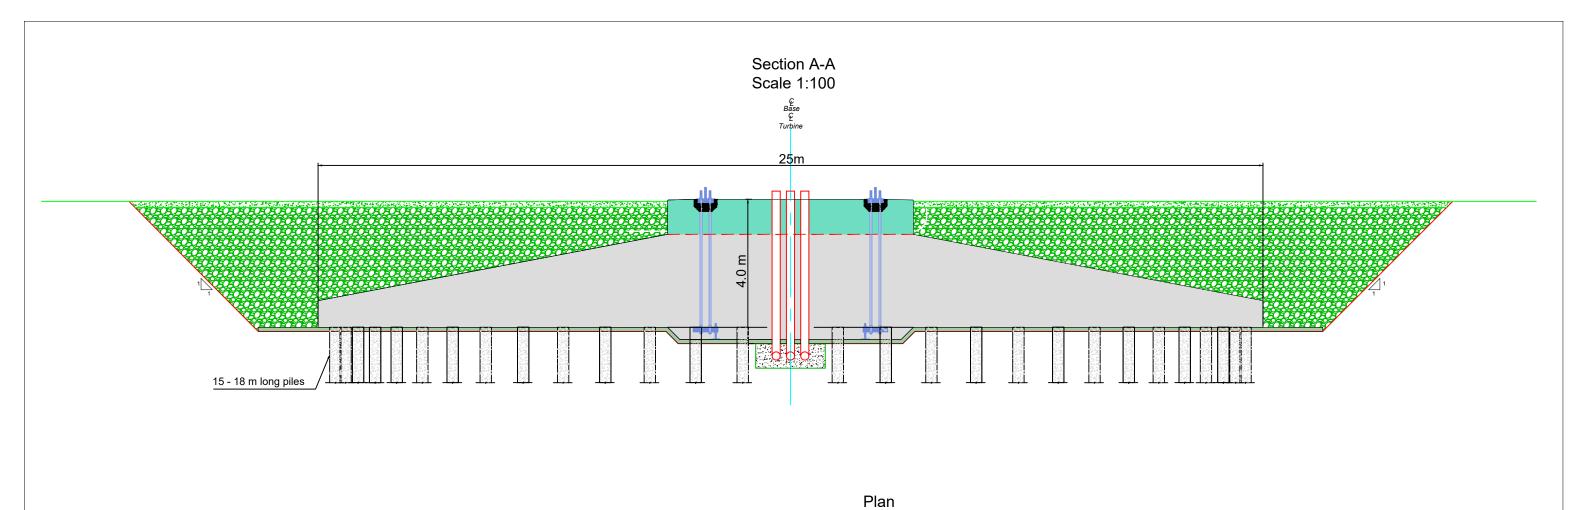

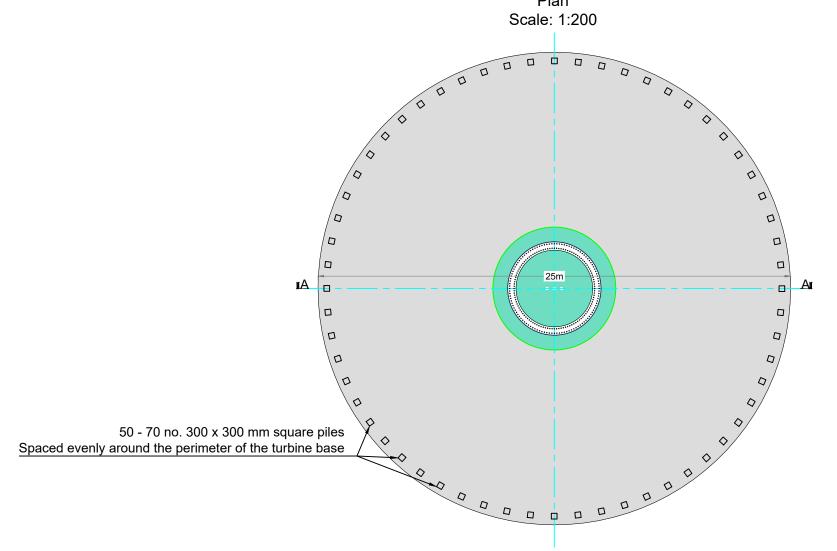


#### PROJECT TITLE: Cooloo Wind Farm, Co. Galway

#### Driven Pile Foundations Details

231103   190723 - 26   As Shown @ A3	PROJECT No.:		DRAWING No.:	SCALE:
BV: BV:	231103		190723 - 26	As Shown @ A3
BY: JOB BY: RD 24.09.2025 P01			DATE:	REVISION.:
	BY: JOB	BY: RD	24.09.2025	P01



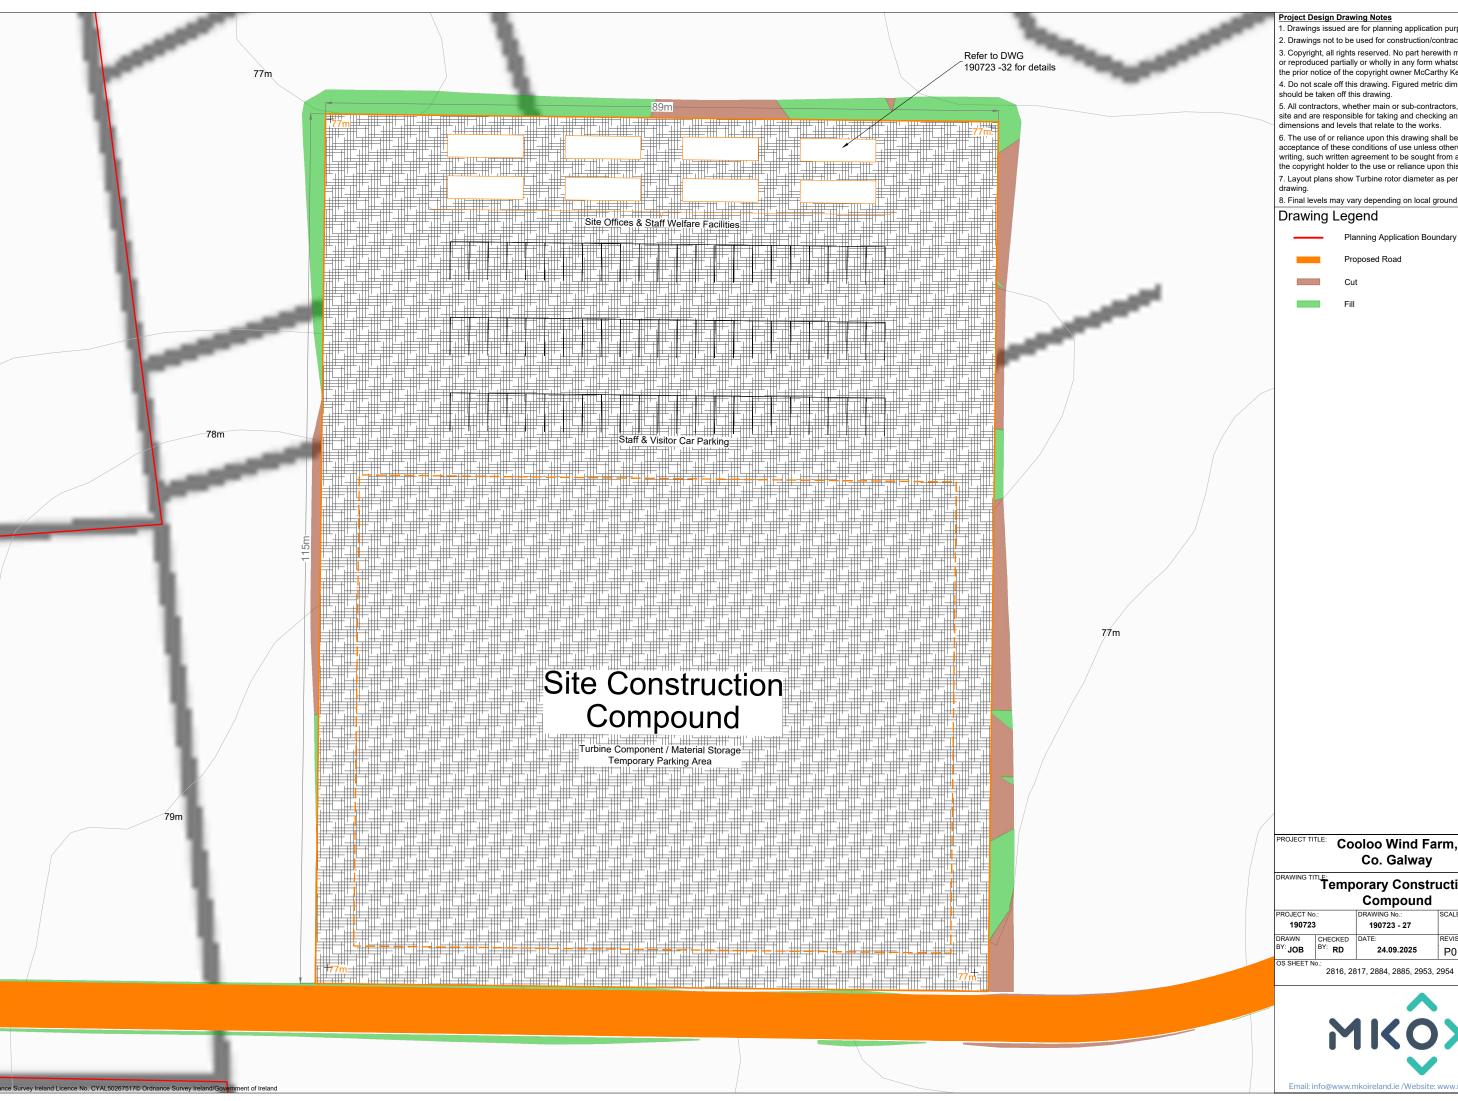

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Planning Application Boundary





### Cooloo Wind Farm, Co. Galway

Temporary Construction Compound

PROJECT No.:		DRAWING No.:	SCALE:
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DRAWN	OFFICE	DATE:	REVISION.:
BY: JOB	BY: RD	24.09.2025	P01



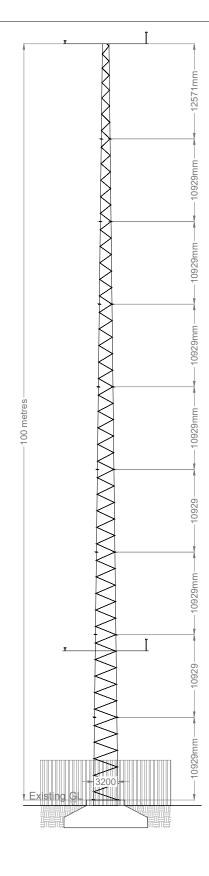

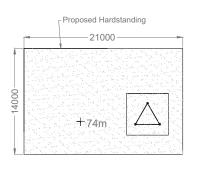

Met Mast Compound Plan



## PROJECT TITLE: Cooloo Wind Farm, Co. Galway

DRAWING TITLE:


### Meteorological (Met) Mast

		SCALE:	
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DRAWN CHECKED	DATE:	REVISION.:	
BY: JOB BY: RD	24.09.2025	P01	



Note

For illustrative purposes only exact details to be confirmed

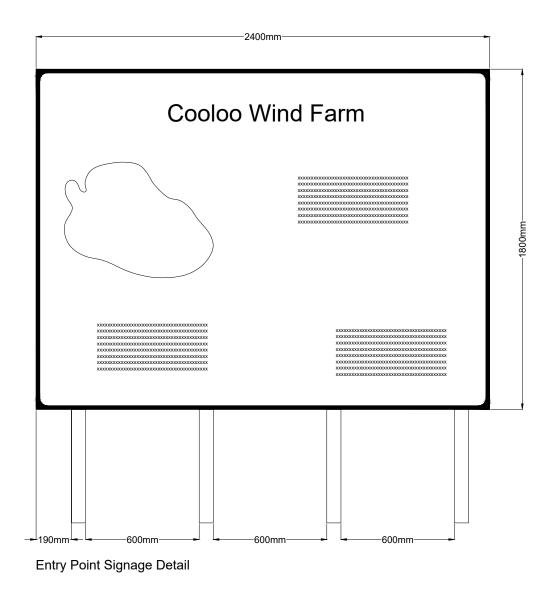


PROJECT TITLE: Cooloo Wind Farm,
Co. Galway

### Operational Stage Signage Detail

190723		190723 - 29	1 :20 @ A3
DRAWN	CHECKED	DATE:	P01
BY: <b>JOB</b>	BY: RD	24.09.2025	



Note Wheel washes will be appropriately located at all entrances used during construction of the wind farm

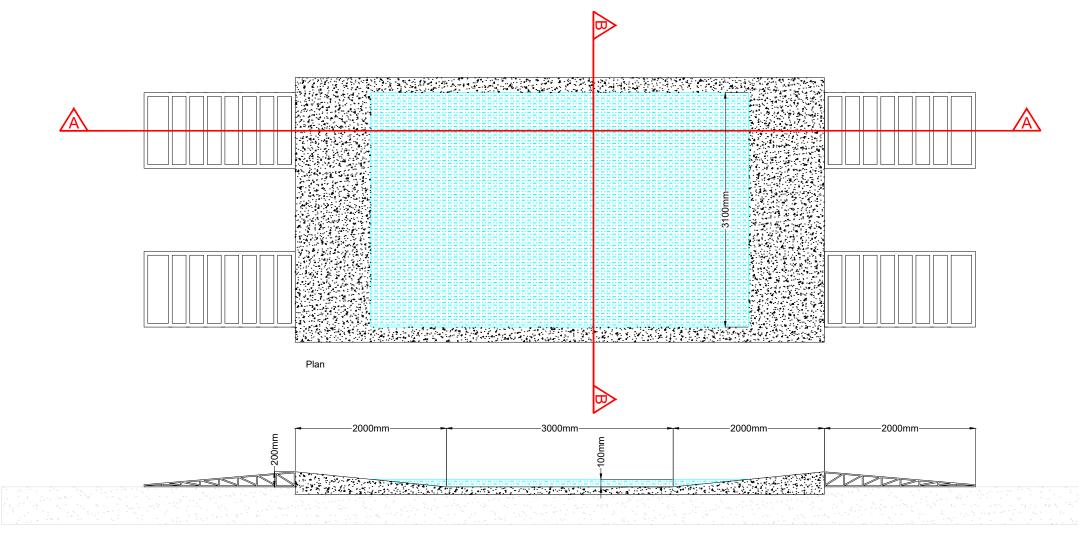

Section A-A




Section B-B

### Cooloo Wind Farm, Co. Galway

### **Wheel Wash Detail**


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DRAWN	CHECKED	DATE:	REVISION.:
BY: JOB	BY: RD	24.09.2025	P01




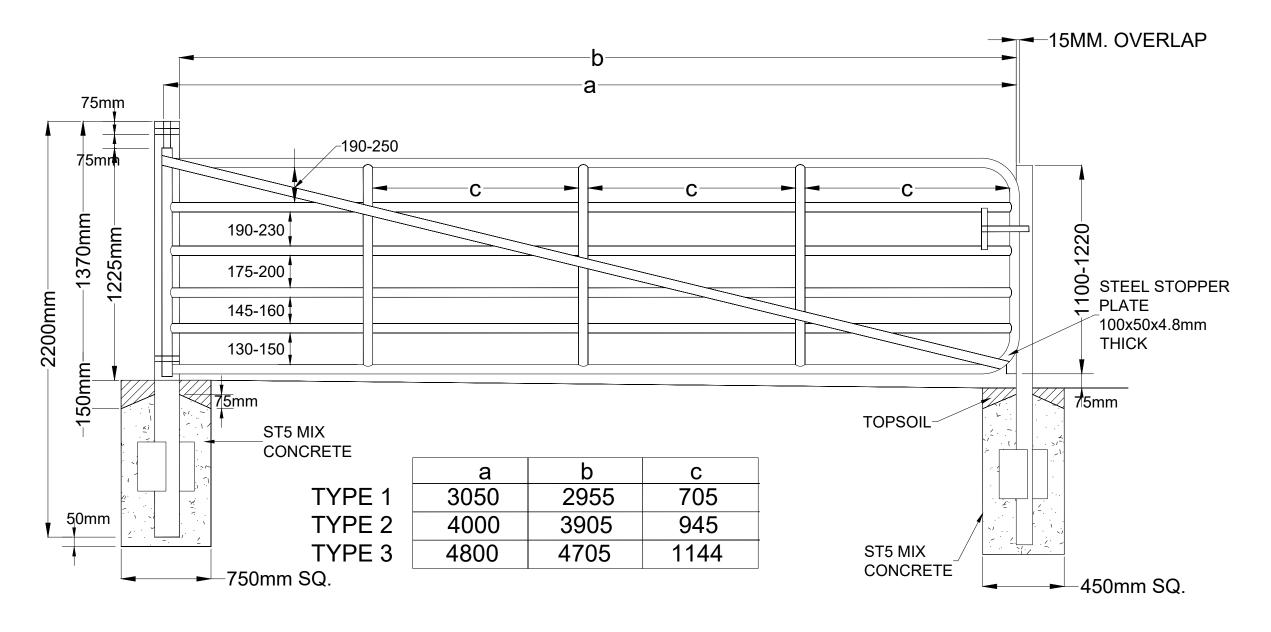







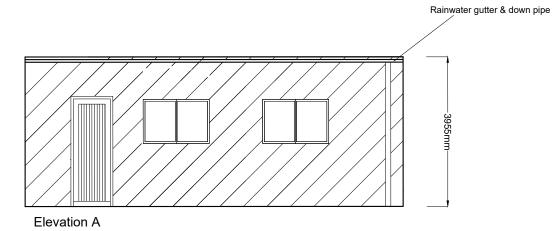


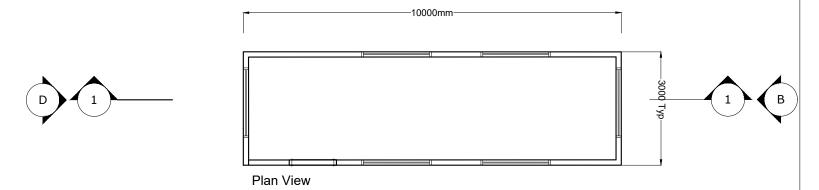




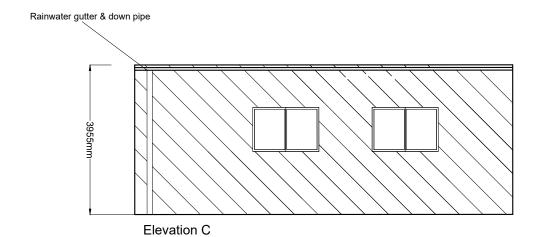

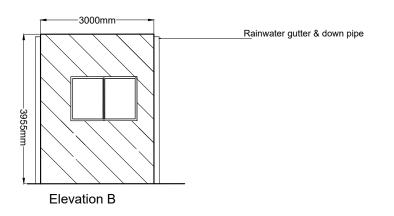

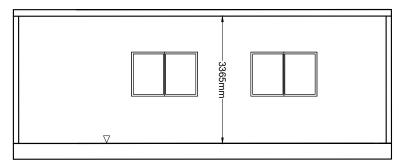



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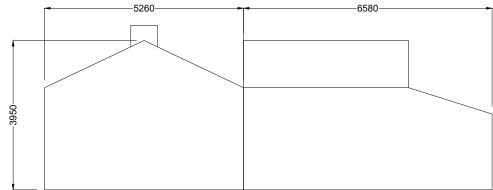
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DRAWING		e Office &	Staff	
	F	acilities De	tail	
PROJECT N	No.:	DRAWING No.:	SCALE:	
190723		190723 - 32	1:100 @ A3	
DRAWN	CHECKED	DATE:	REVISION.:	
BY: JOB	BY: RD	24.09.2025	P01	
			1	
	N	IKC		

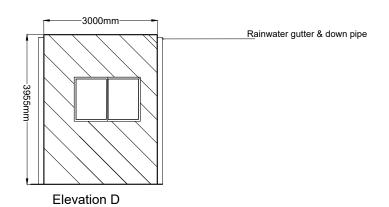Email: info@www.mkoireland.ie /Website: www.mkoireland.ie



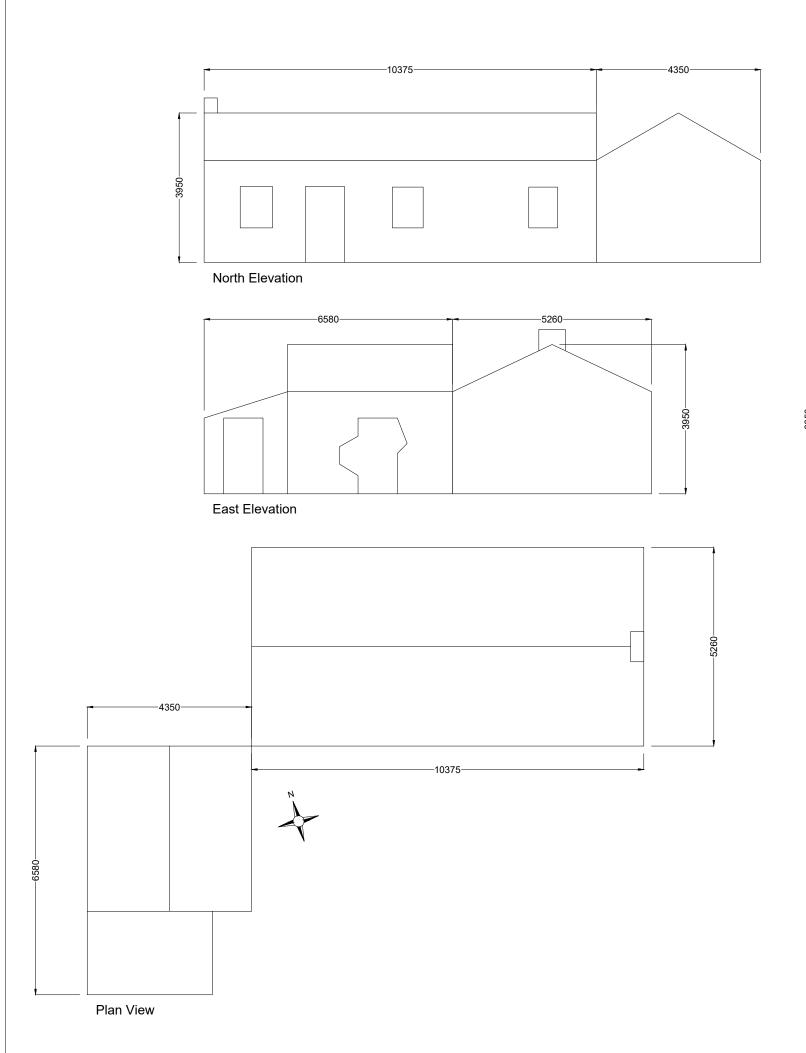

South Elevation

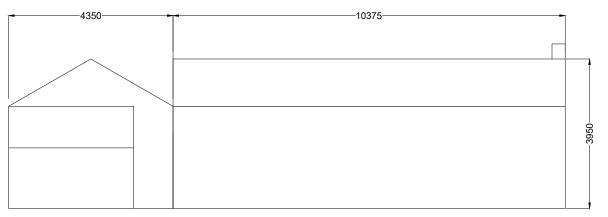

West Elevation








PROJECT TITLE: Cooloo Wind Farm, Co. Galway

AWING TITLE:

### **Building for Demolition**

PROJECT No.:		DRAWING No.:	SCALE:
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DRAWN	CHECKED	DATE:	REVISION.:
BY: JOB	BY: RD	24.09.2025	P01



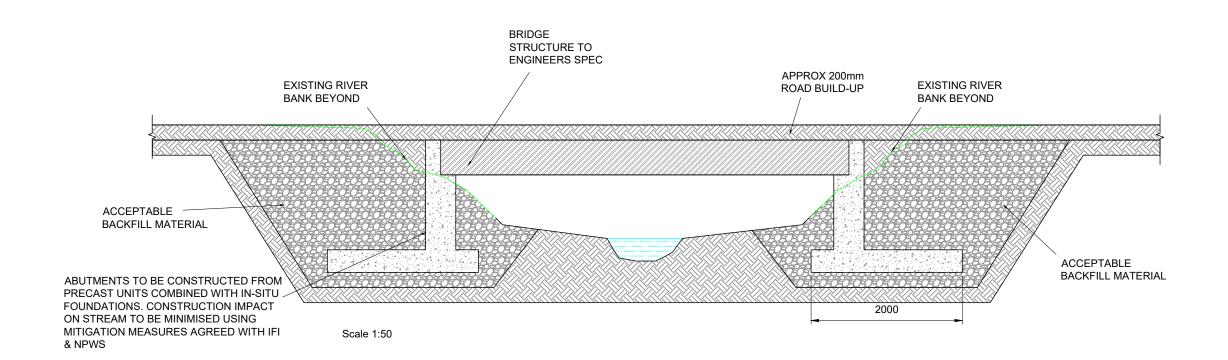


Cooloo Wind Farm,
Co. Galway

DRAWING TITLE:


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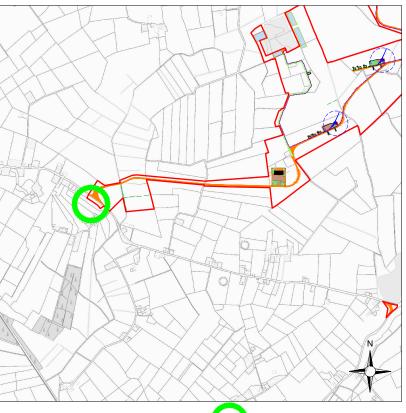
PROJECT No.:		DRAWING No.:	SCALE:
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DRAWN	OTILOTED	DATE:	REVISION.:
BY: JOB	BY: RD	24.09.2025	P01





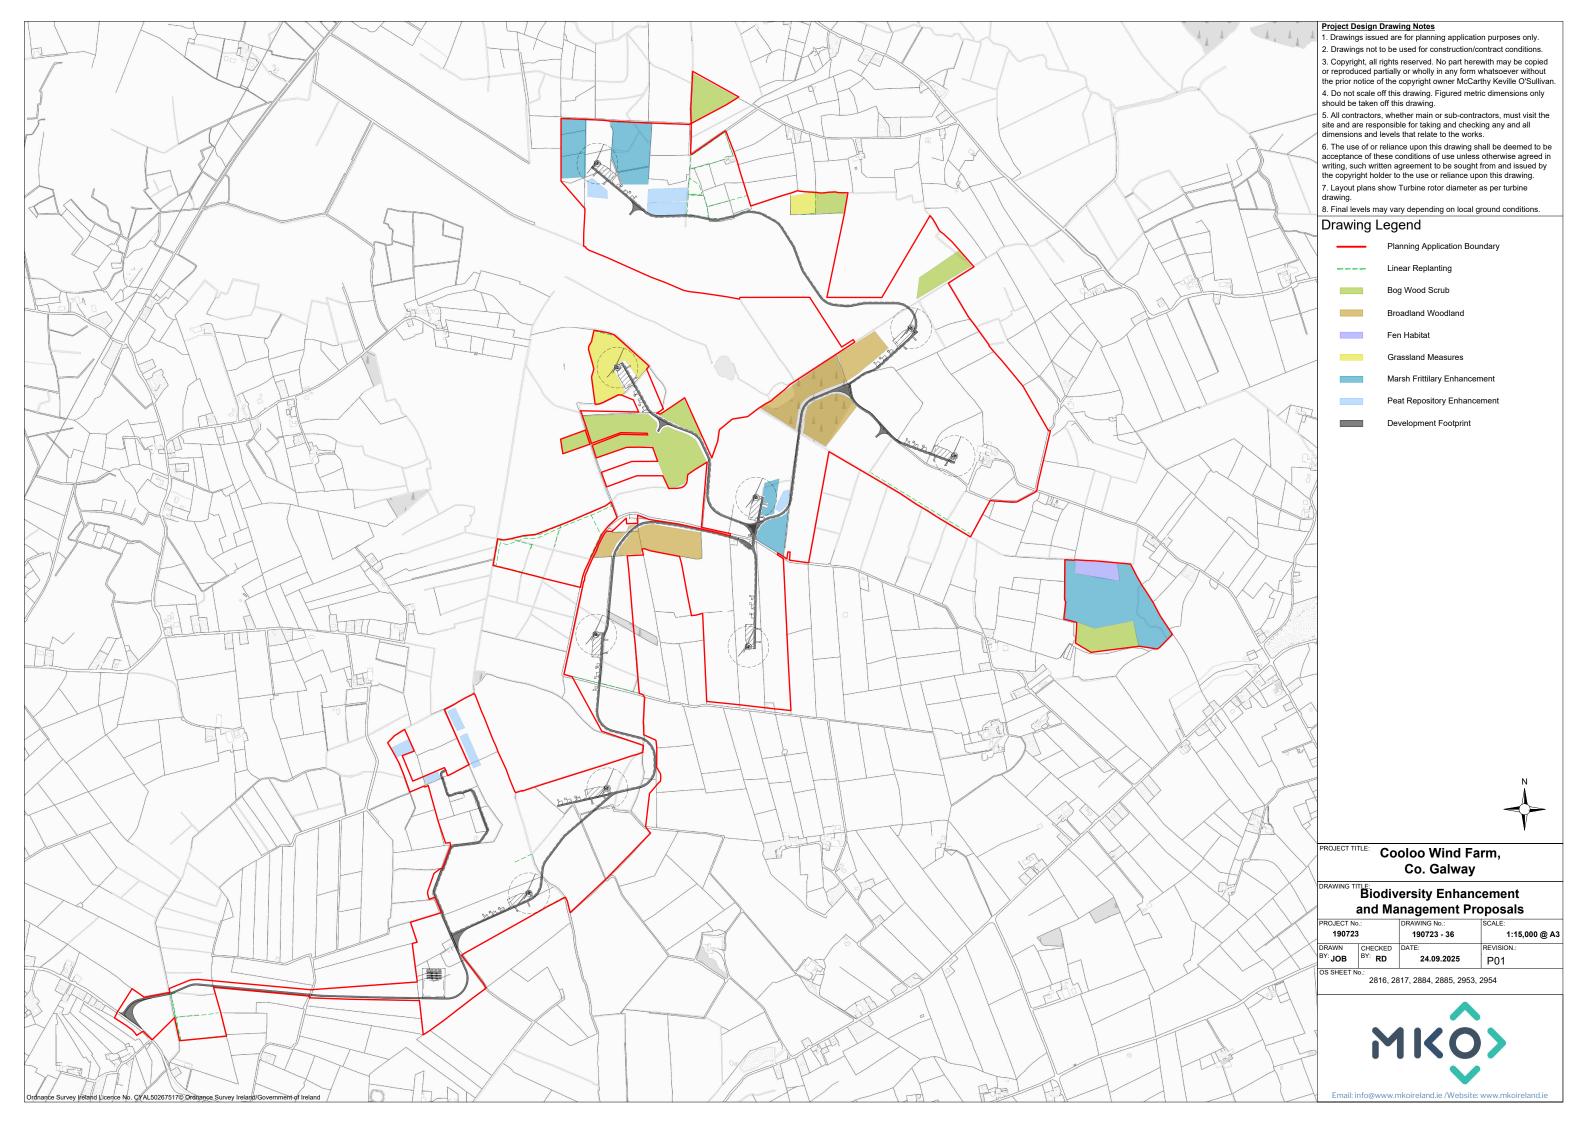



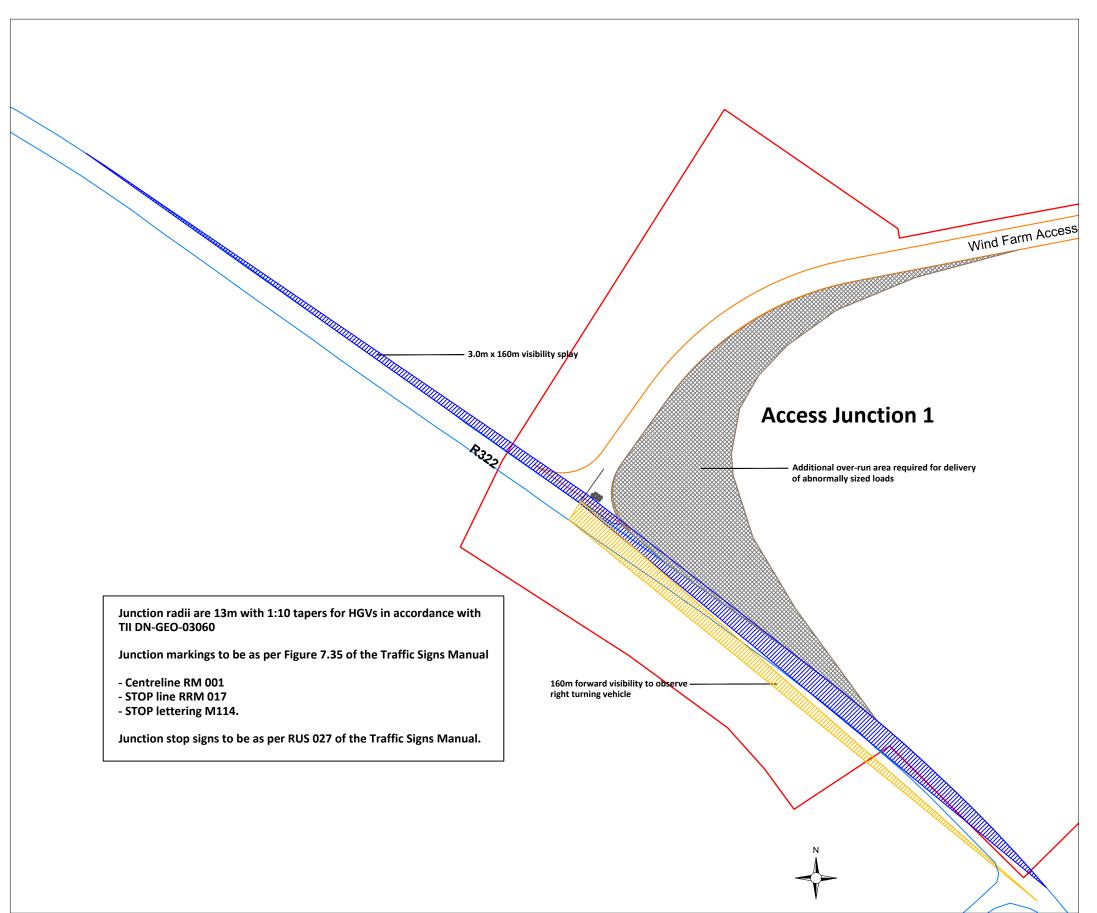


Cooloo Wind Farm,
Co. Galway


Proposed Access
Junction 1

PROJECT No.: DRAWING No.: 190723 1:1,000 @ A3

DRAWN BY: JOB BY: RD 24.09.2025 P01



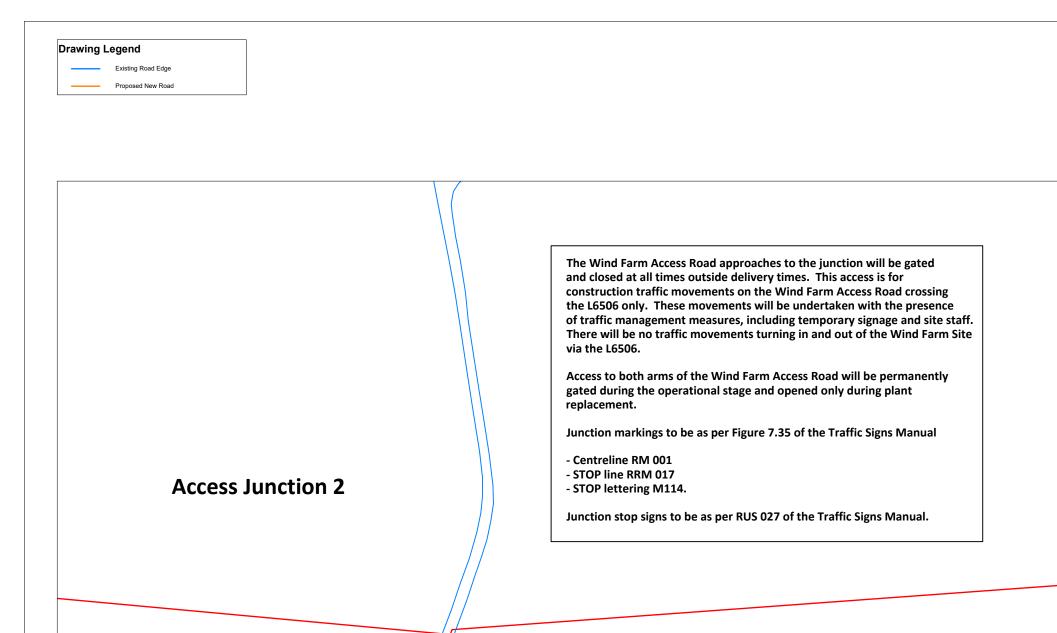

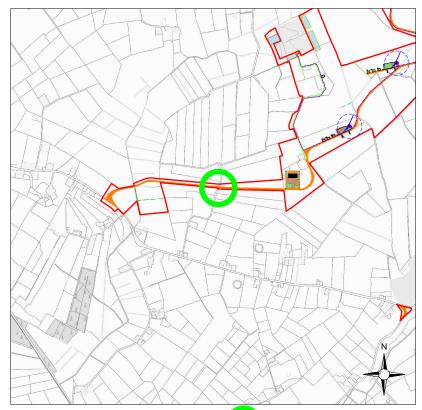



Wind Farm Access



Cooloo Wind Farm,
Co. Galway

Proposed Access

Junction 2

Indiaming No.: | SCALE:

 PROJECT No.:
 DRAWING No.:
 SCALE:


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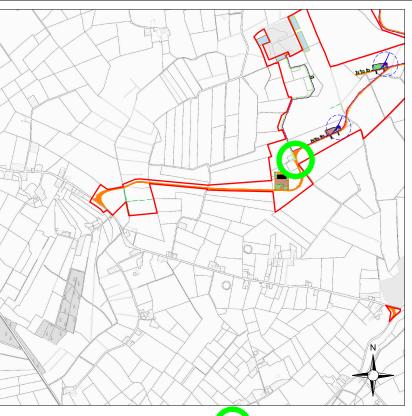
 DRAWN
 CHECKED
 DATE:
 REVISION.:

 BY: JOB
 BY: RD
 24.09.2025
 P01







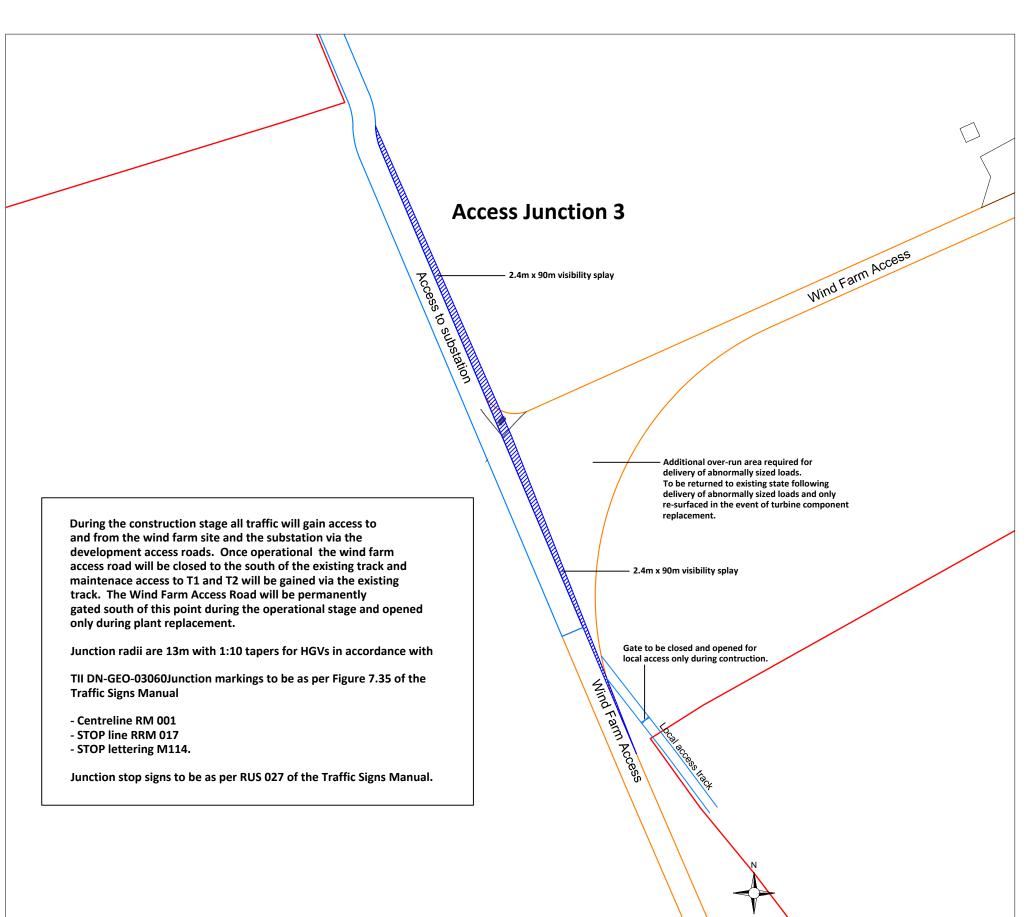




PROJECT TITLE: Cooloo Wind Farm,
Co. Galway


Proposed Access
Junction 3

190723		190723 - 39	1:1,000 @ A3
DRAWN	OFFECTED	DATE:	REVISION.:
BY: JOB	BY: RD	24.09.2025	P01





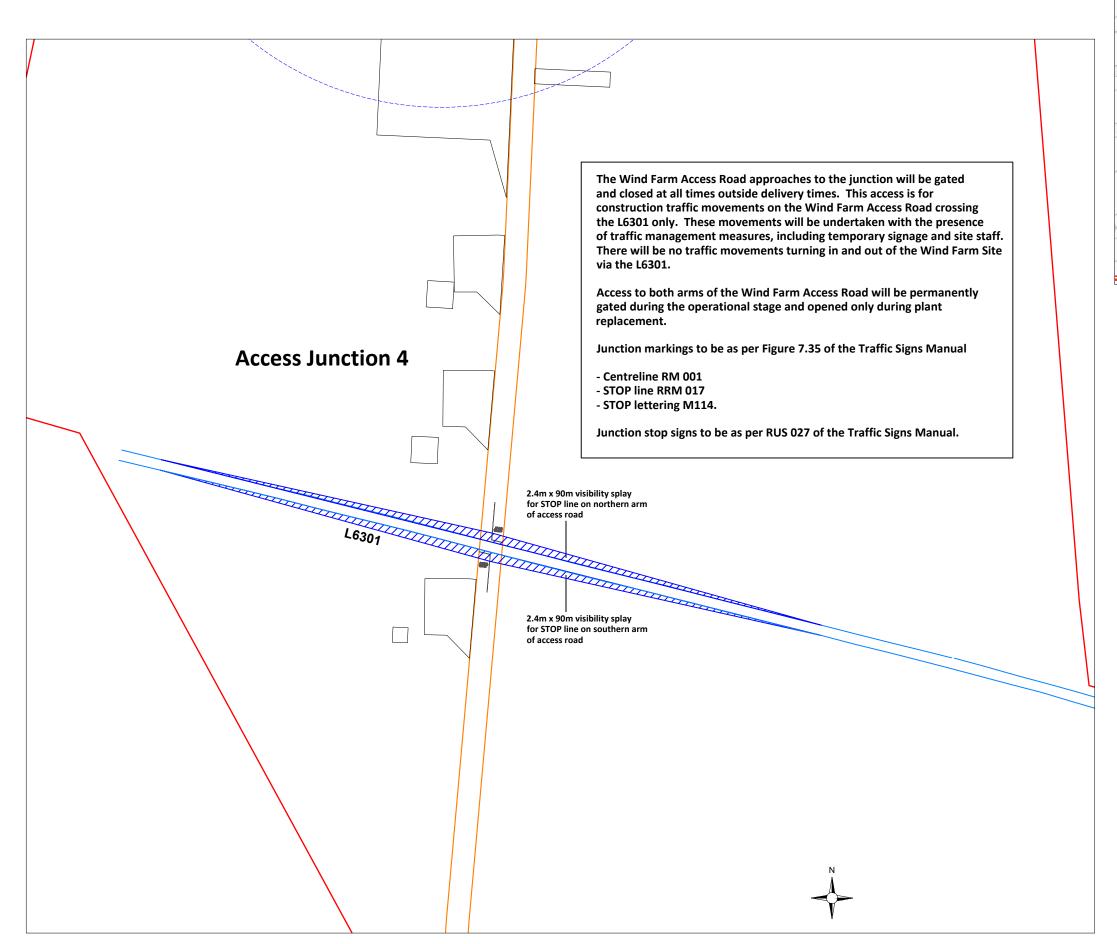

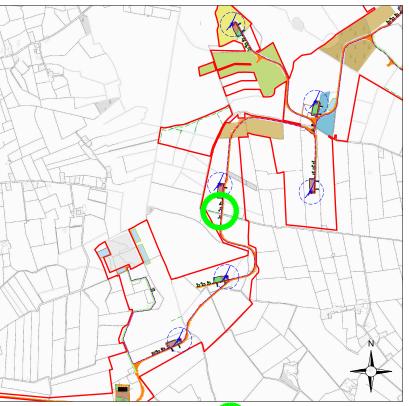

1:25,000 Location on Context Map


PROJECT TITLE: Cooloo Wind Farm,
Co. Galway


Proposed Access
Junction 4

190723		190723 - 40	1:1,000 @ A3
DRAWN BY: <b>JOB</b>	CHECKED BY: RD	DATE: <b>24.09.2025</b>	P01





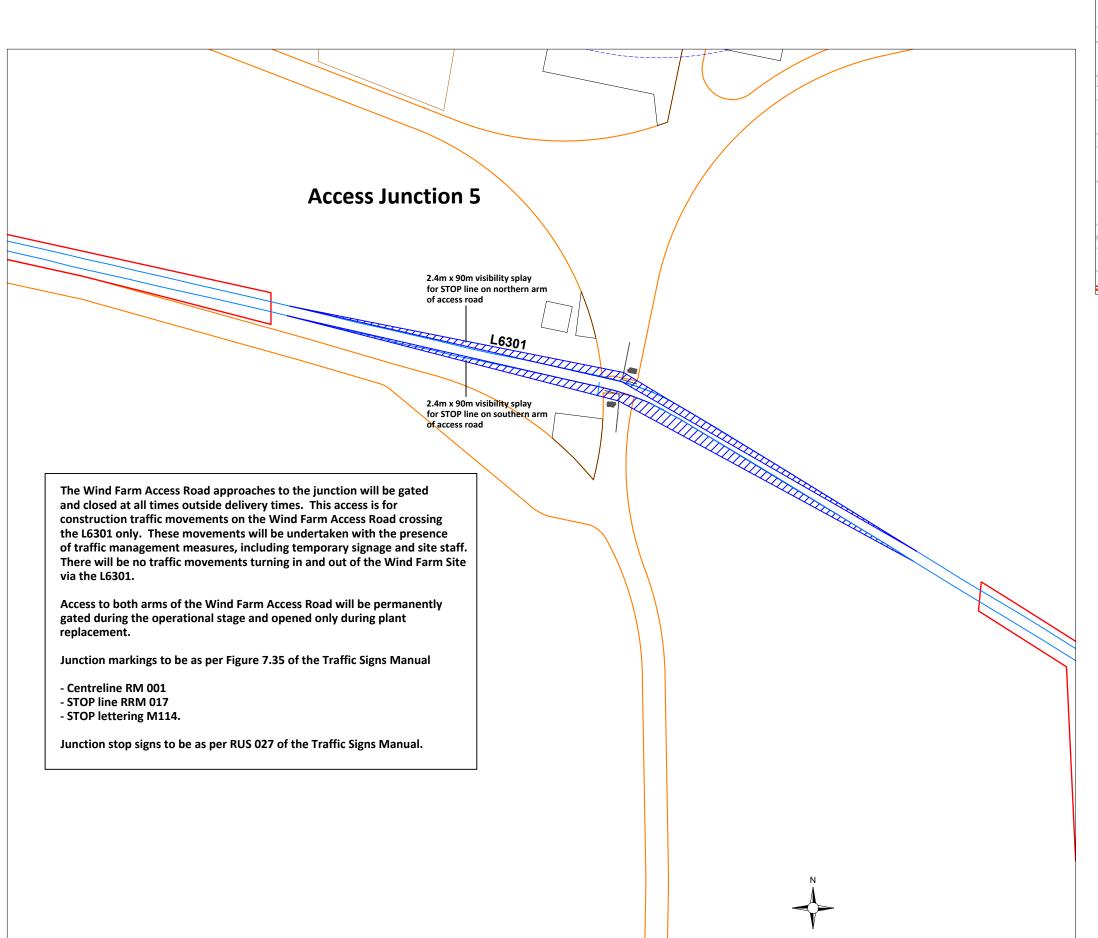

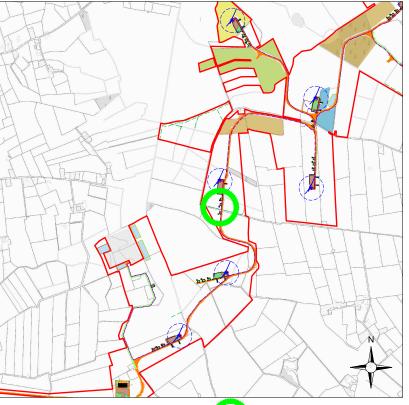


PROJECT TITLE: Cooloo Wind Farm,
Co. Galway

Proposed Access
Junction 5


PROJECT No.: | DRAWING No.: | SCALE: | 190723 | 190723 - 41 | 1:1,000 @ A3 | DRAWN | CHECKED | BY: JOB | BY: RD | 24.09.2025 | P01 |



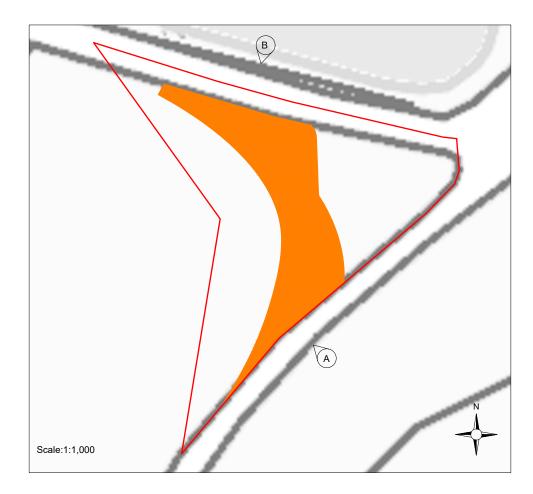





Elevation A - Vegetation and Fencing to be removed and re-instated post construction Scale:1:200

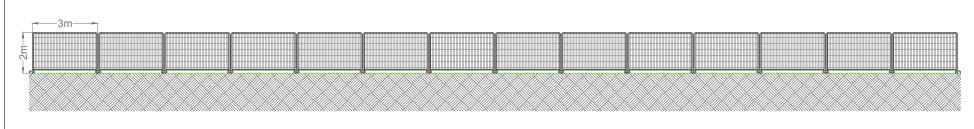



Elevation A - Temporary Fencing during construction Scale:1:200

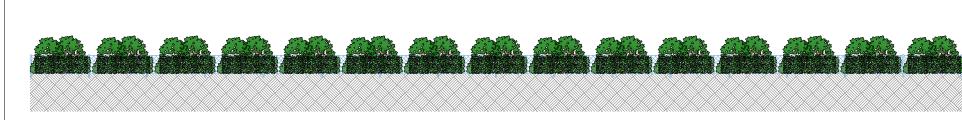


Elevation A - Vegetation and Fencing re-instated post construction Scale:1:200

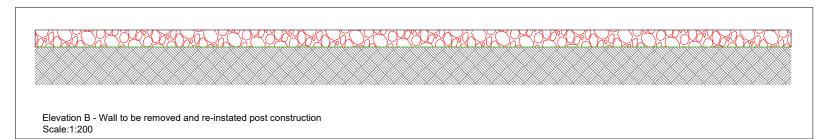

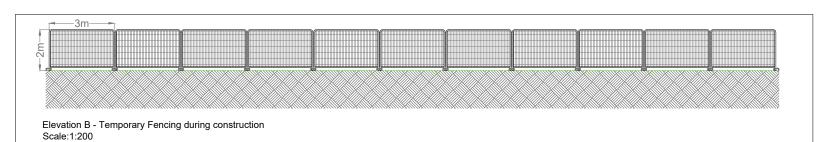


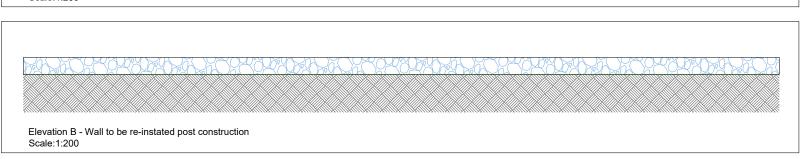



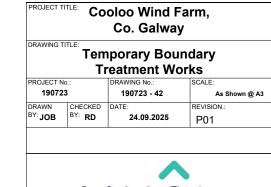




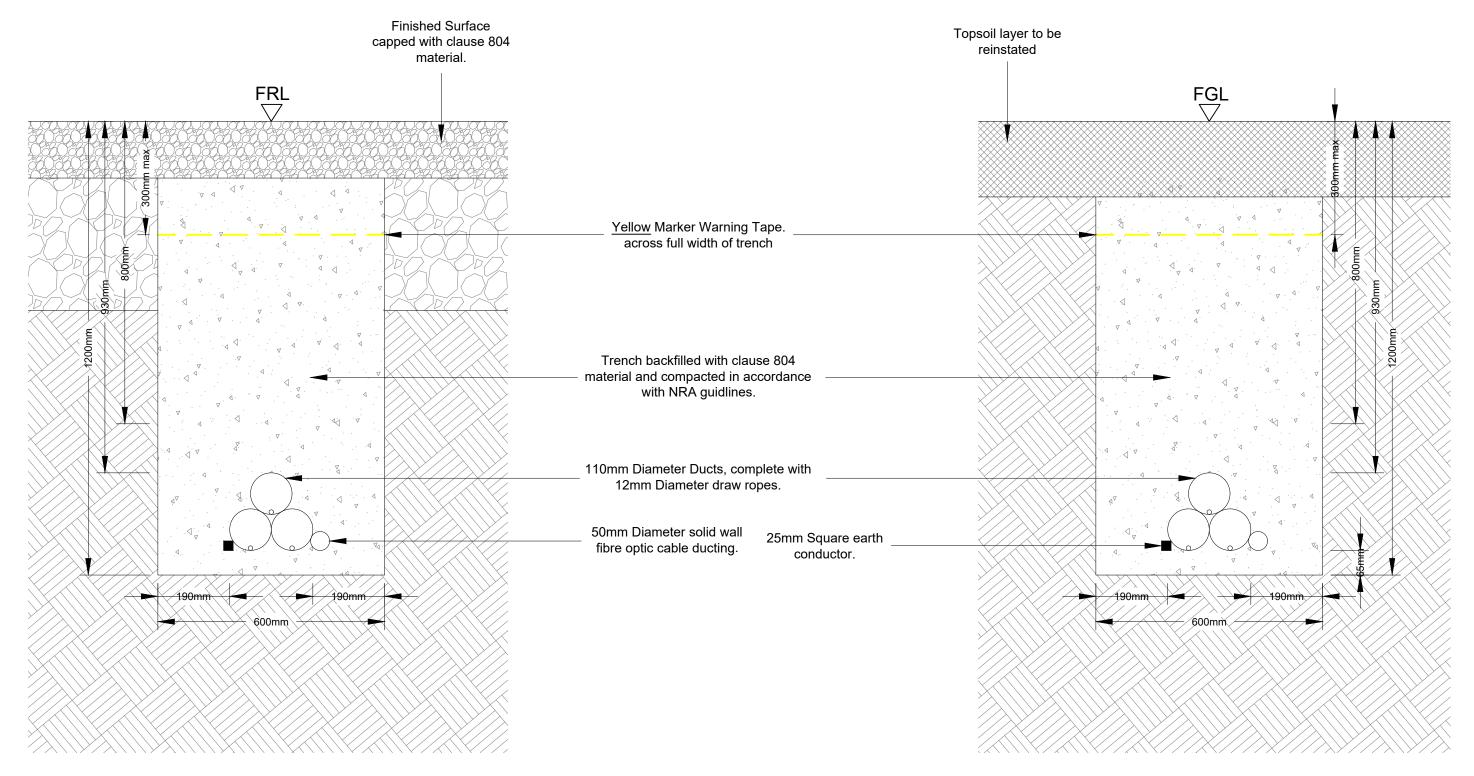


33kV Cable - On Road Trench Detail - Cross Section


33kV Cable - Off Road Trench Detail - Cross Section

PROJECT TITLE: Cooloo Wind Farm, Co. Galway  DRAWING TITLE:  33kV Cable Trench Sections					
19072	:3	190723 - 43	1:10 @ A3		
DRAWN BY: <b>JOB</b>	CHECKED BY: RD	DATE: 24.09.2025	REVISION.:		
	Y	IKC	<b>&gt;</b>		

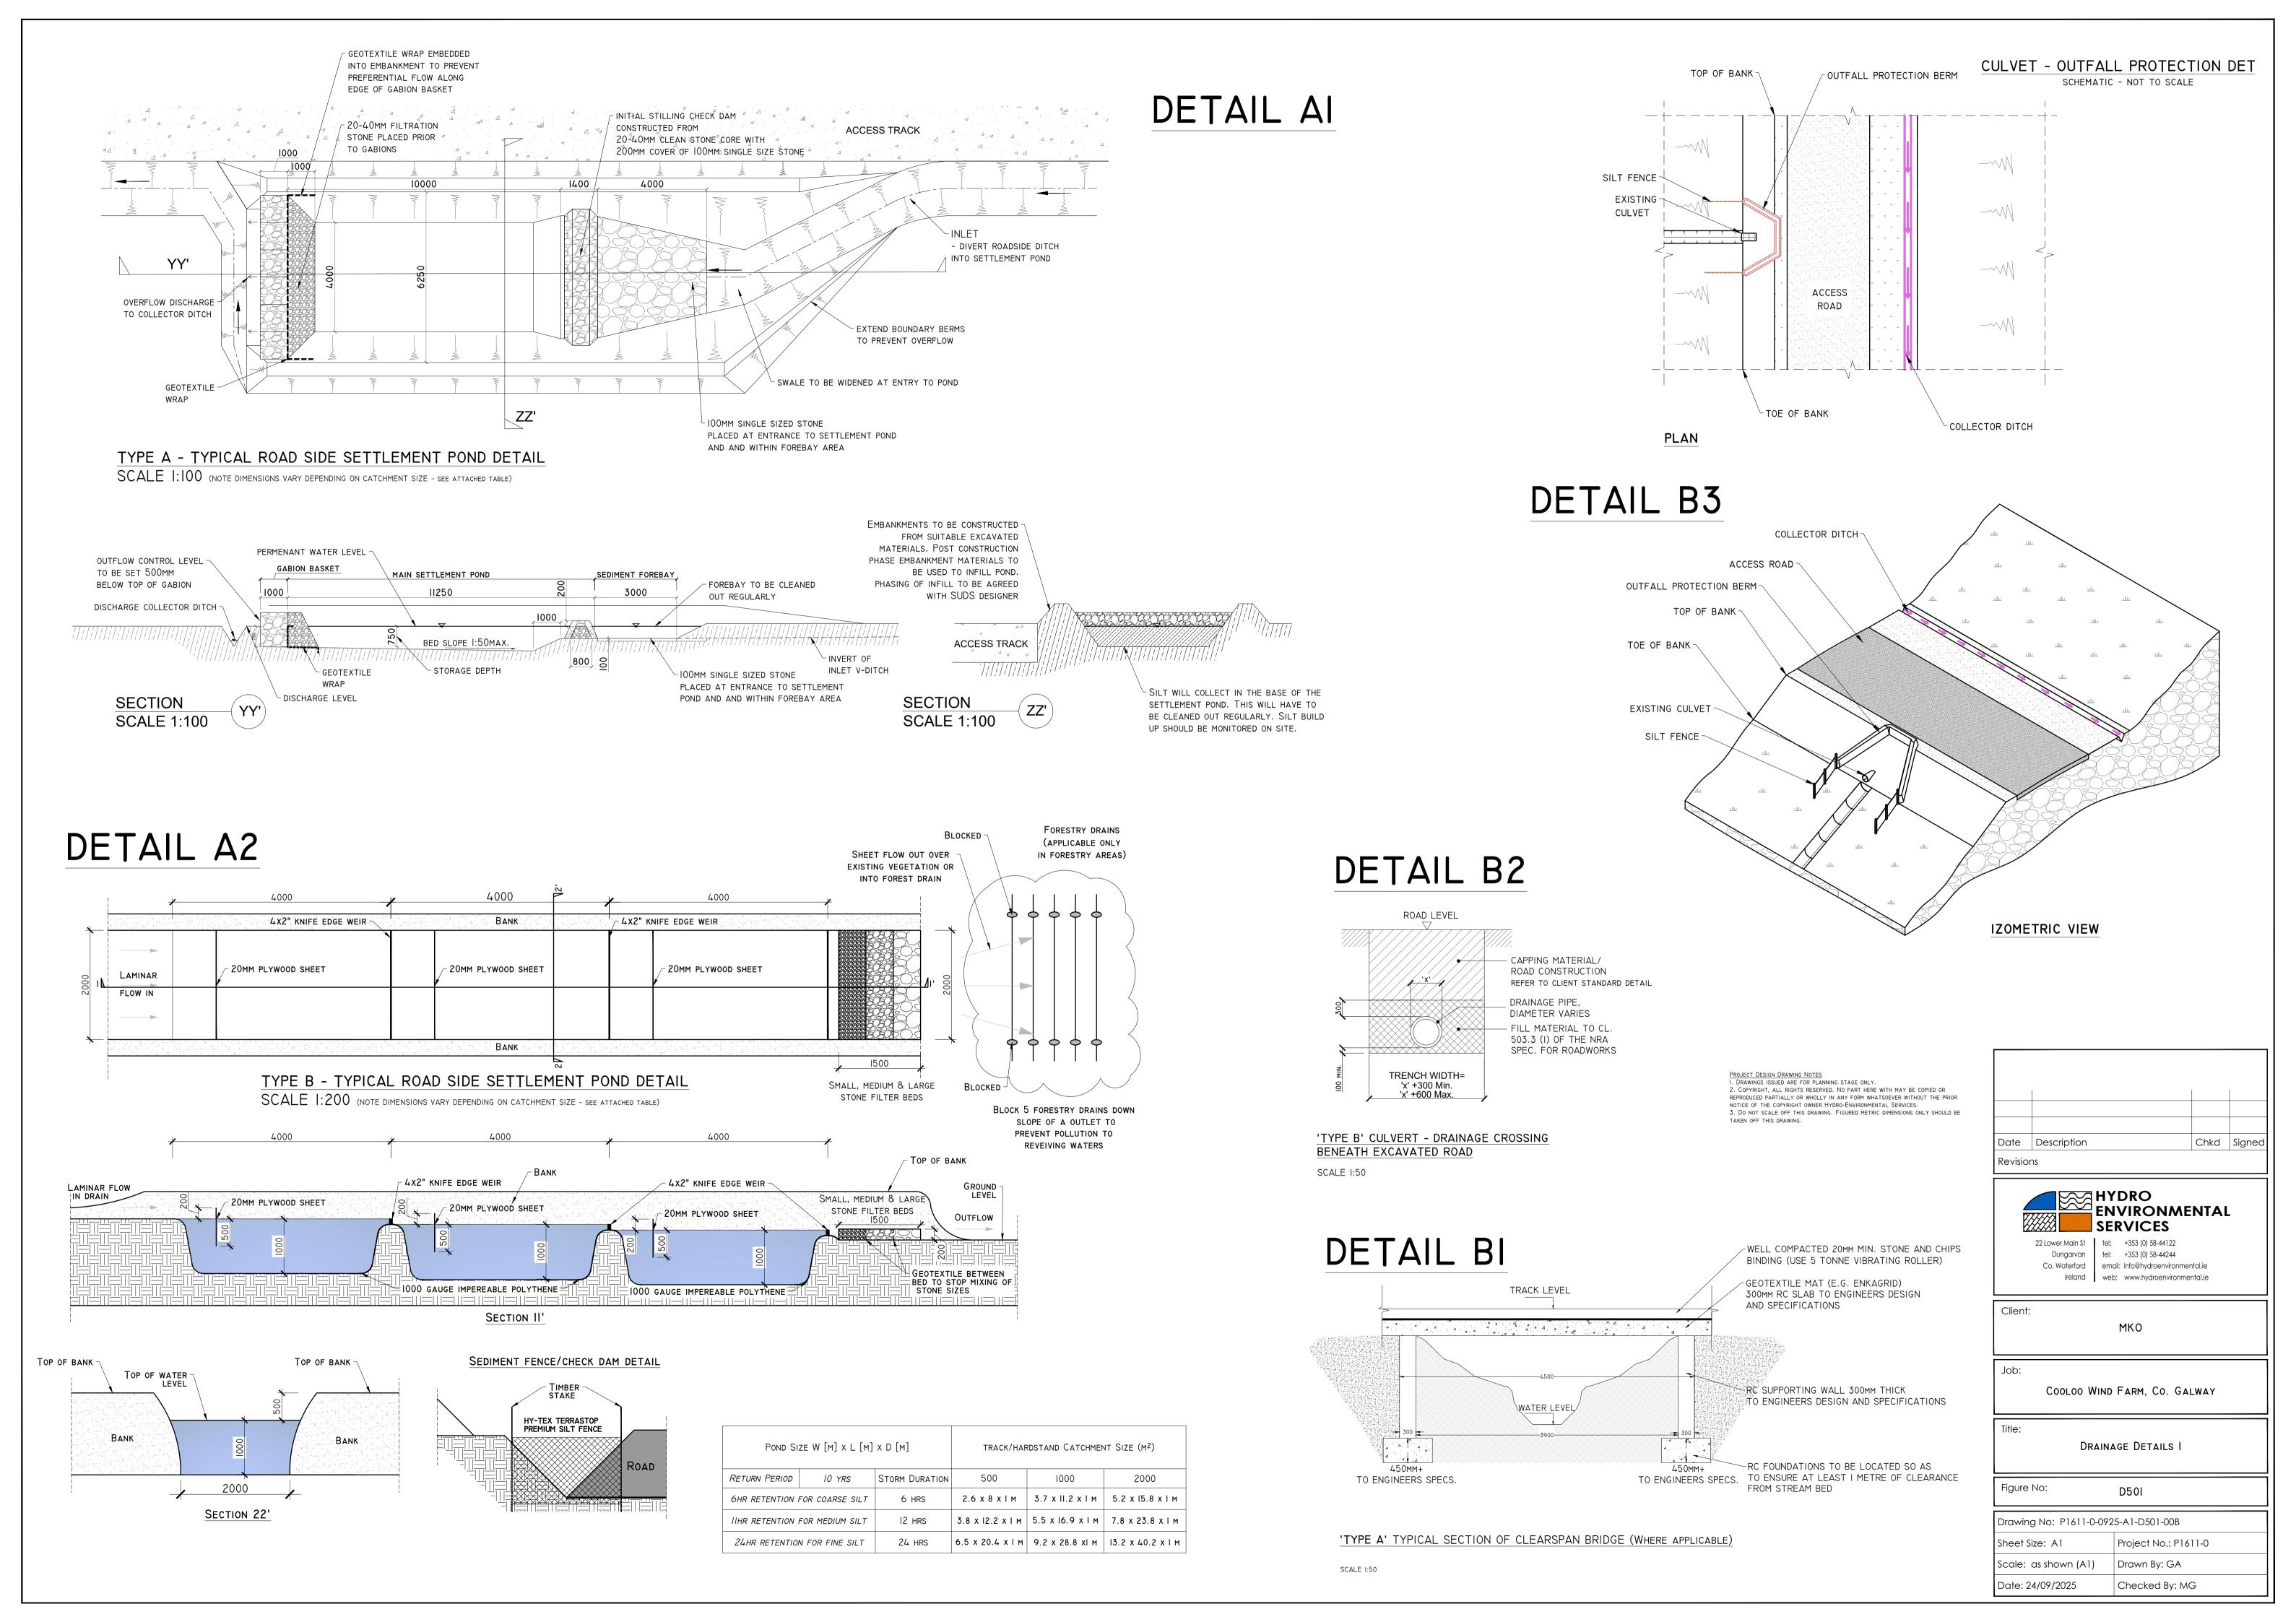

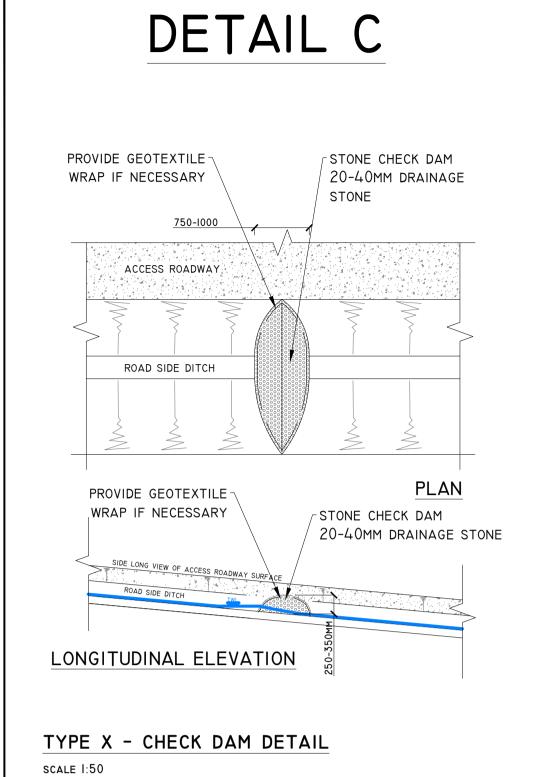

## DETAIL D

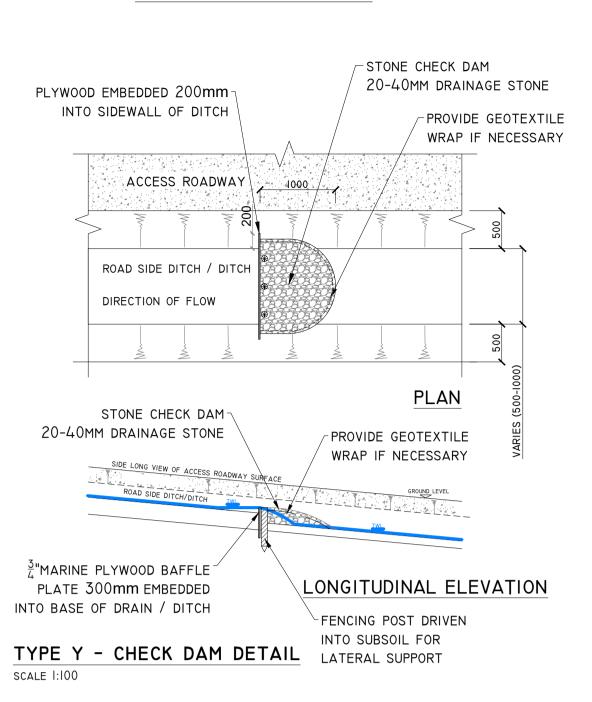

## NOTE: SPACING OF CHECK DAMS ALONG CENTRELINE AND SCOUR PROTECTION BELOW EACH CHECK DAM DETAIL CI

TEMPORARY CHECK DAM / SETTLEMENT POND OVERFLOW

SAND FILLED BAG CONSTRUCTION SCHEMATIC - NOT TO SCALE


BAG FILL MATERIAL EITHER

AGGREGATE, SAND OR DRY

SAND - CEMENT MIXTURE

SPILLWAY

## DETAIL E

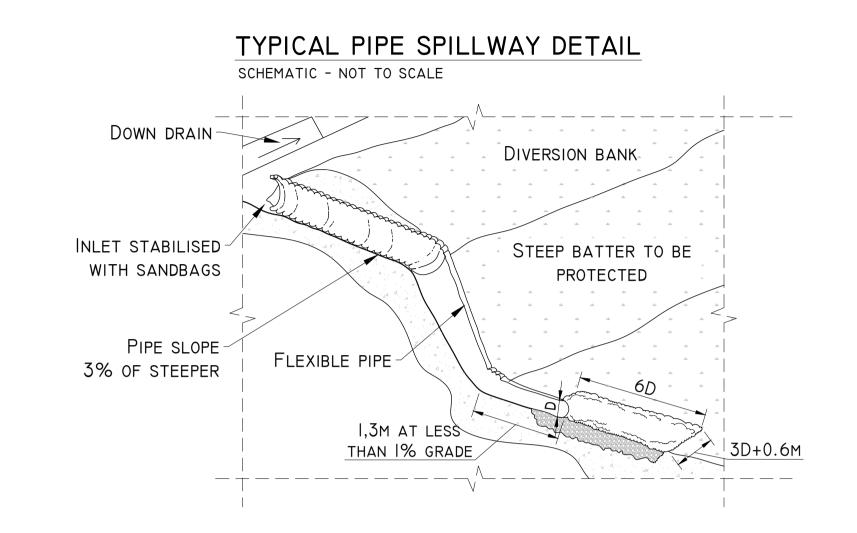


NEEDLE PUNCHED


PREVENT EROSION


GEOFABRIC ON DOWNSTREAM

SPILLWAY PROTECTION TO




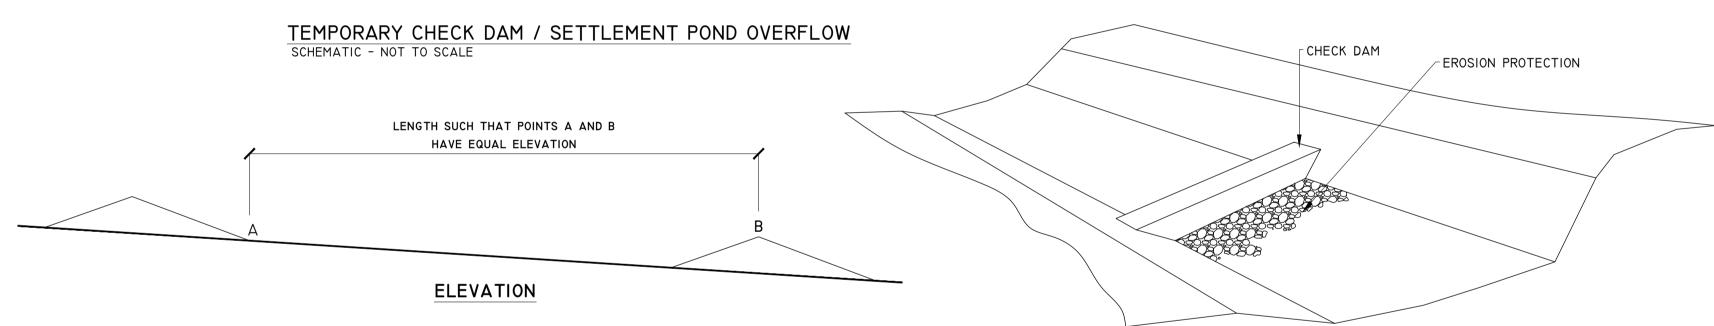

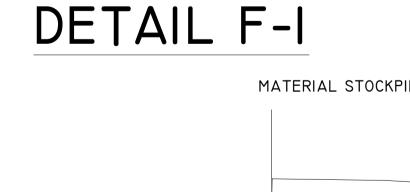


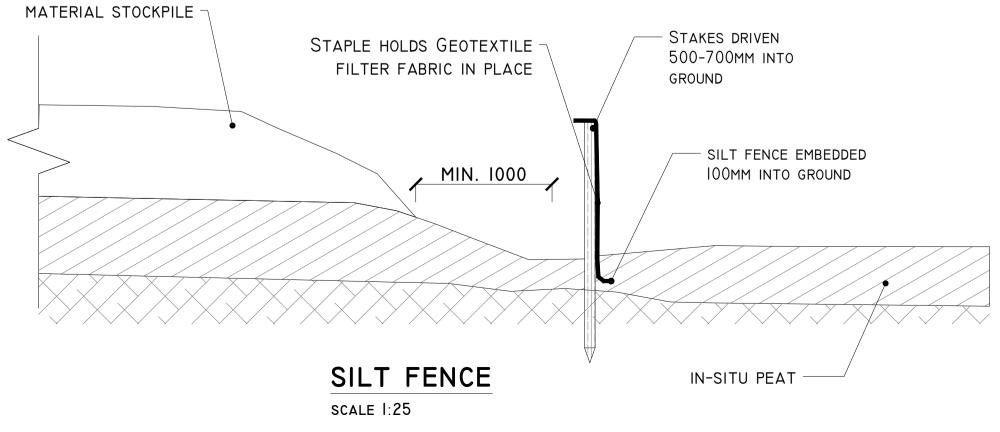

## DETAIL F-II

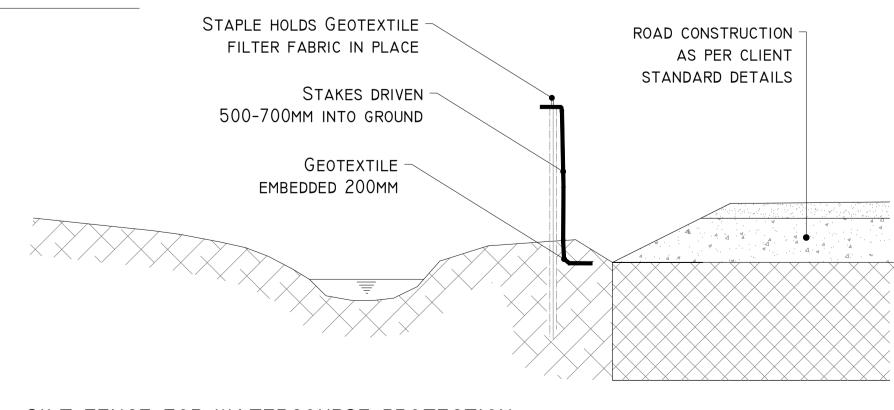

SILT FENCE FOR WATERCOURSE PROTECTION SCALE 1:25

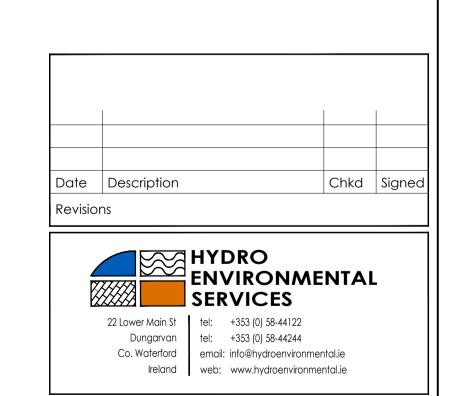

PROJECT DESIGN DRAWING NOTES

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3. DO NOT SCALE OFF THIS DRAWING. FIGURED METRIC DIMENSIONS ONLY SHOULD BE


COOLOO WIND FARM, CO. GALWAY


MKO


DRAINAGE DETAILS 2


Client:


Figure No: D502 Drawing No: P1611-0-0925-A1-D502-00B Project No.: P1611-0 Sheet Size: A1 Scale: as shown (A1) Drawn By: GA Checked By: MG Date: 24/09/2025

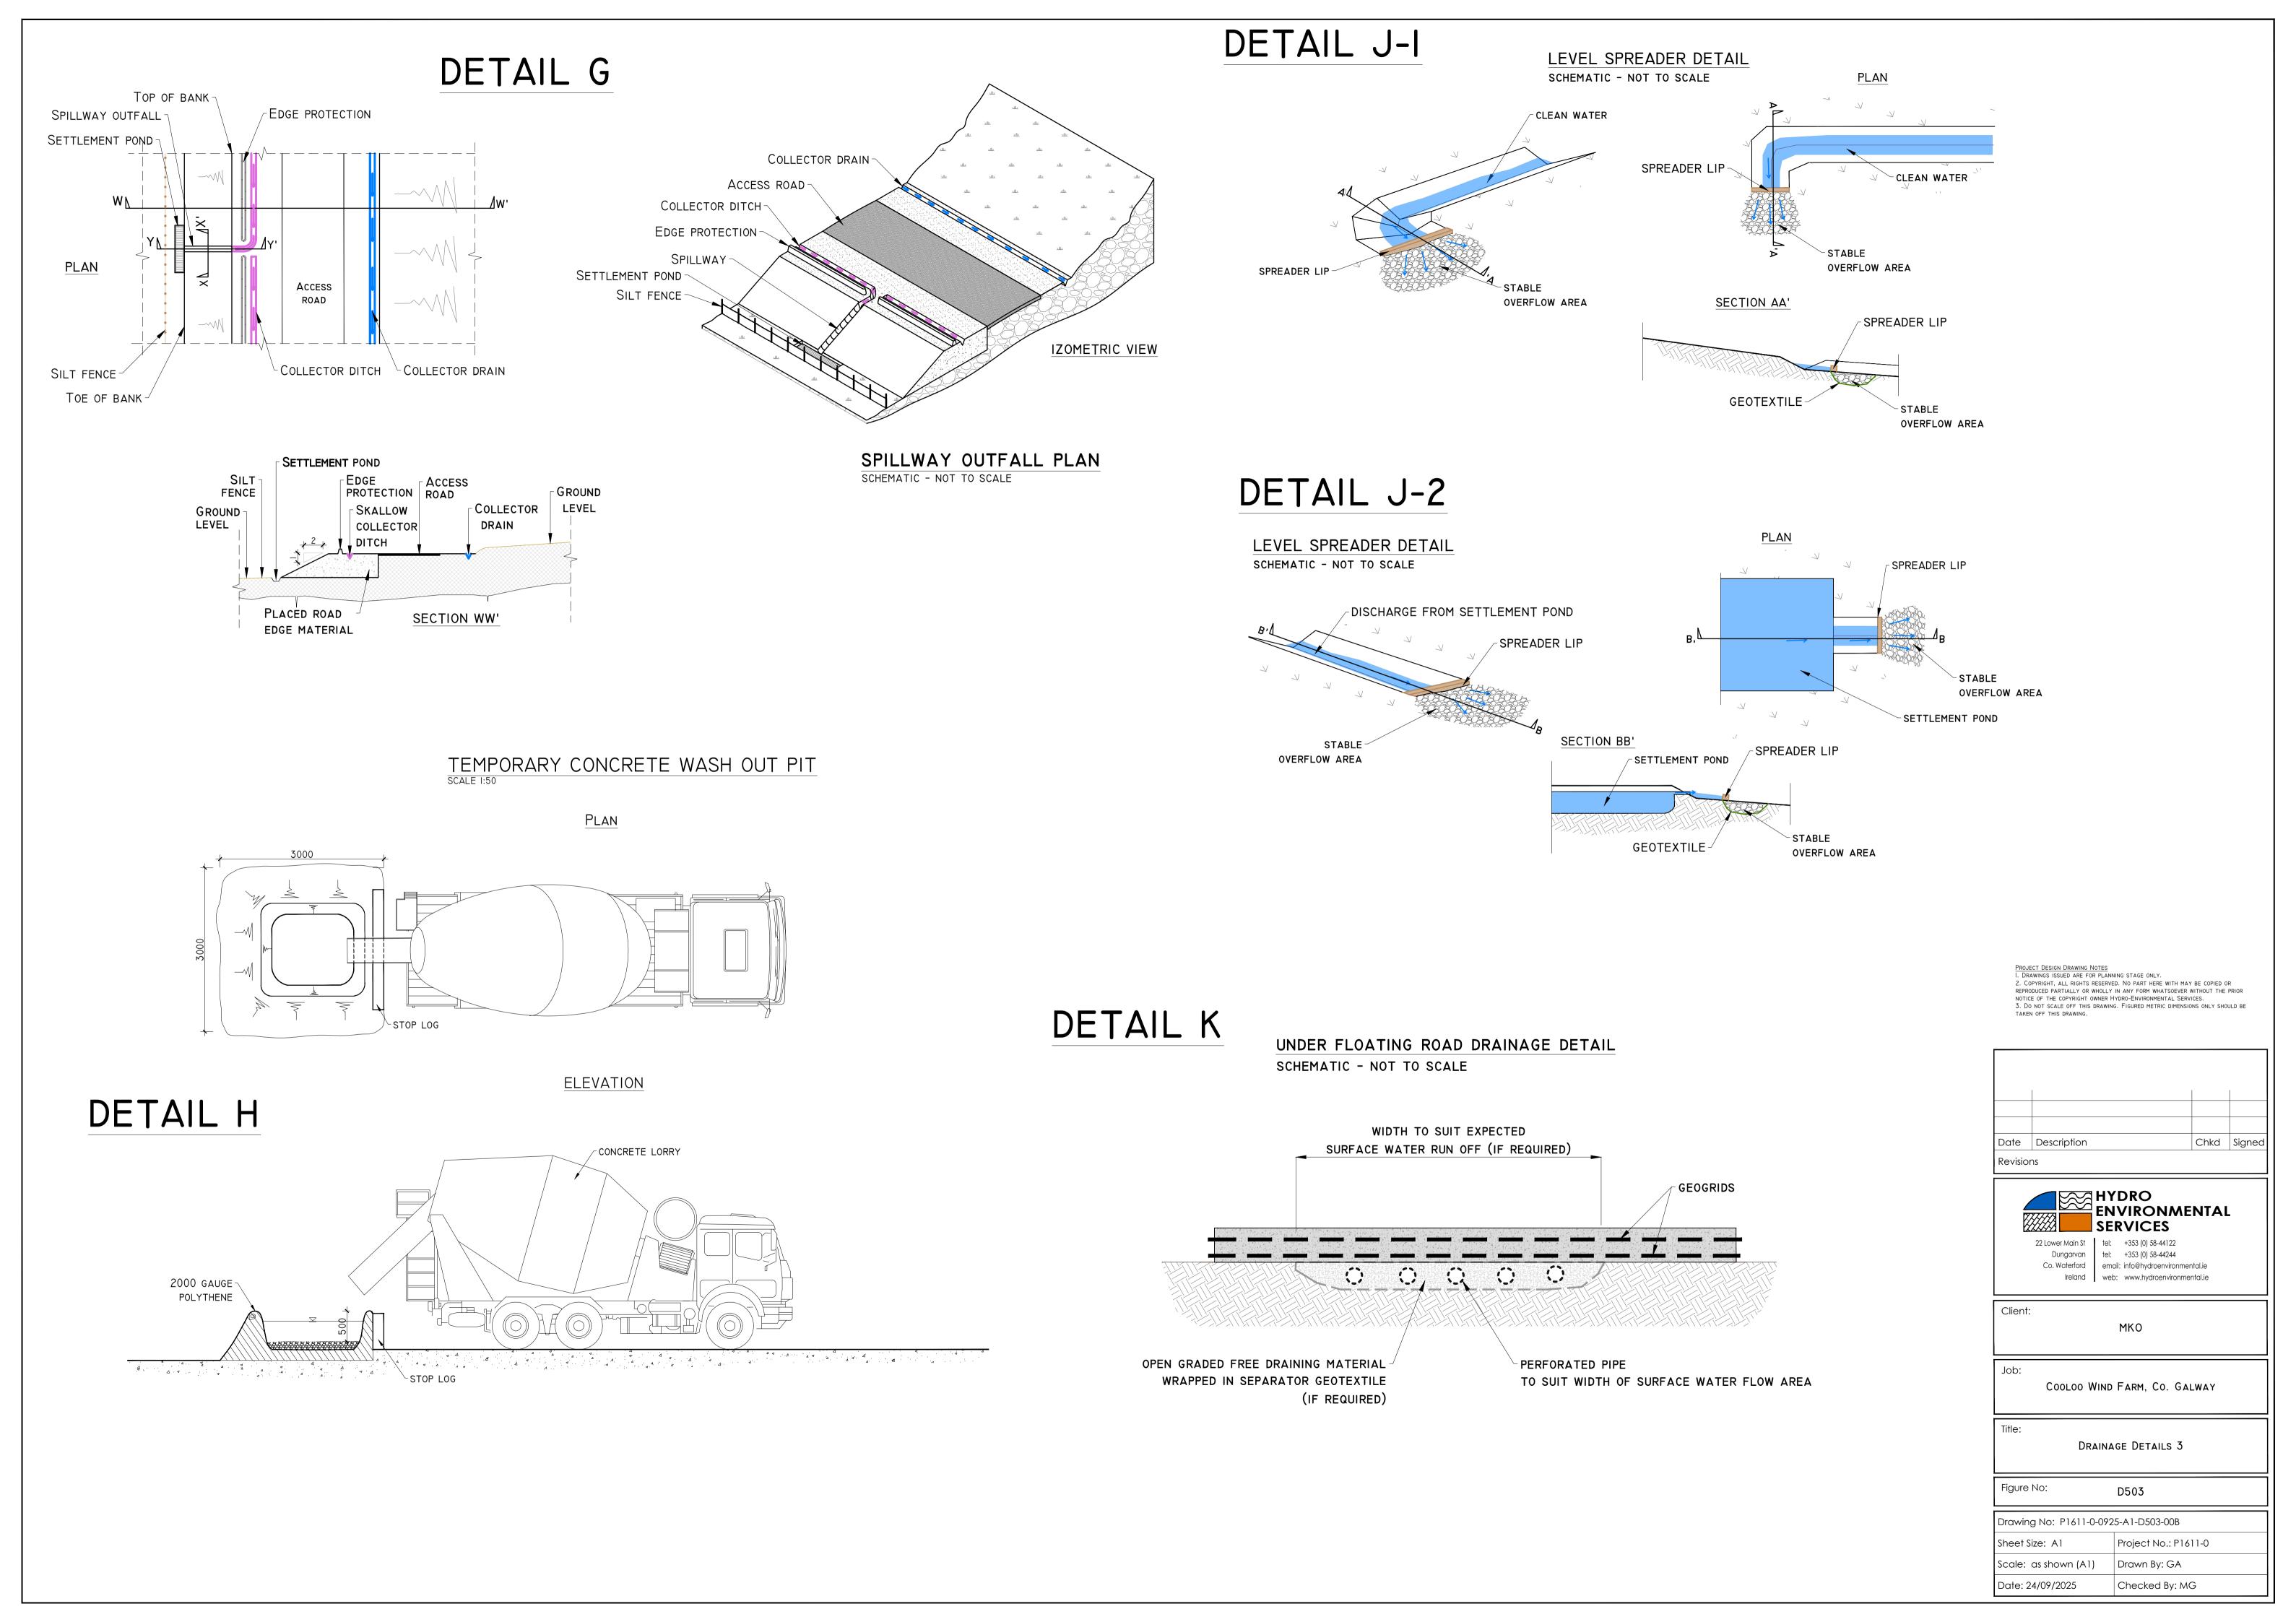


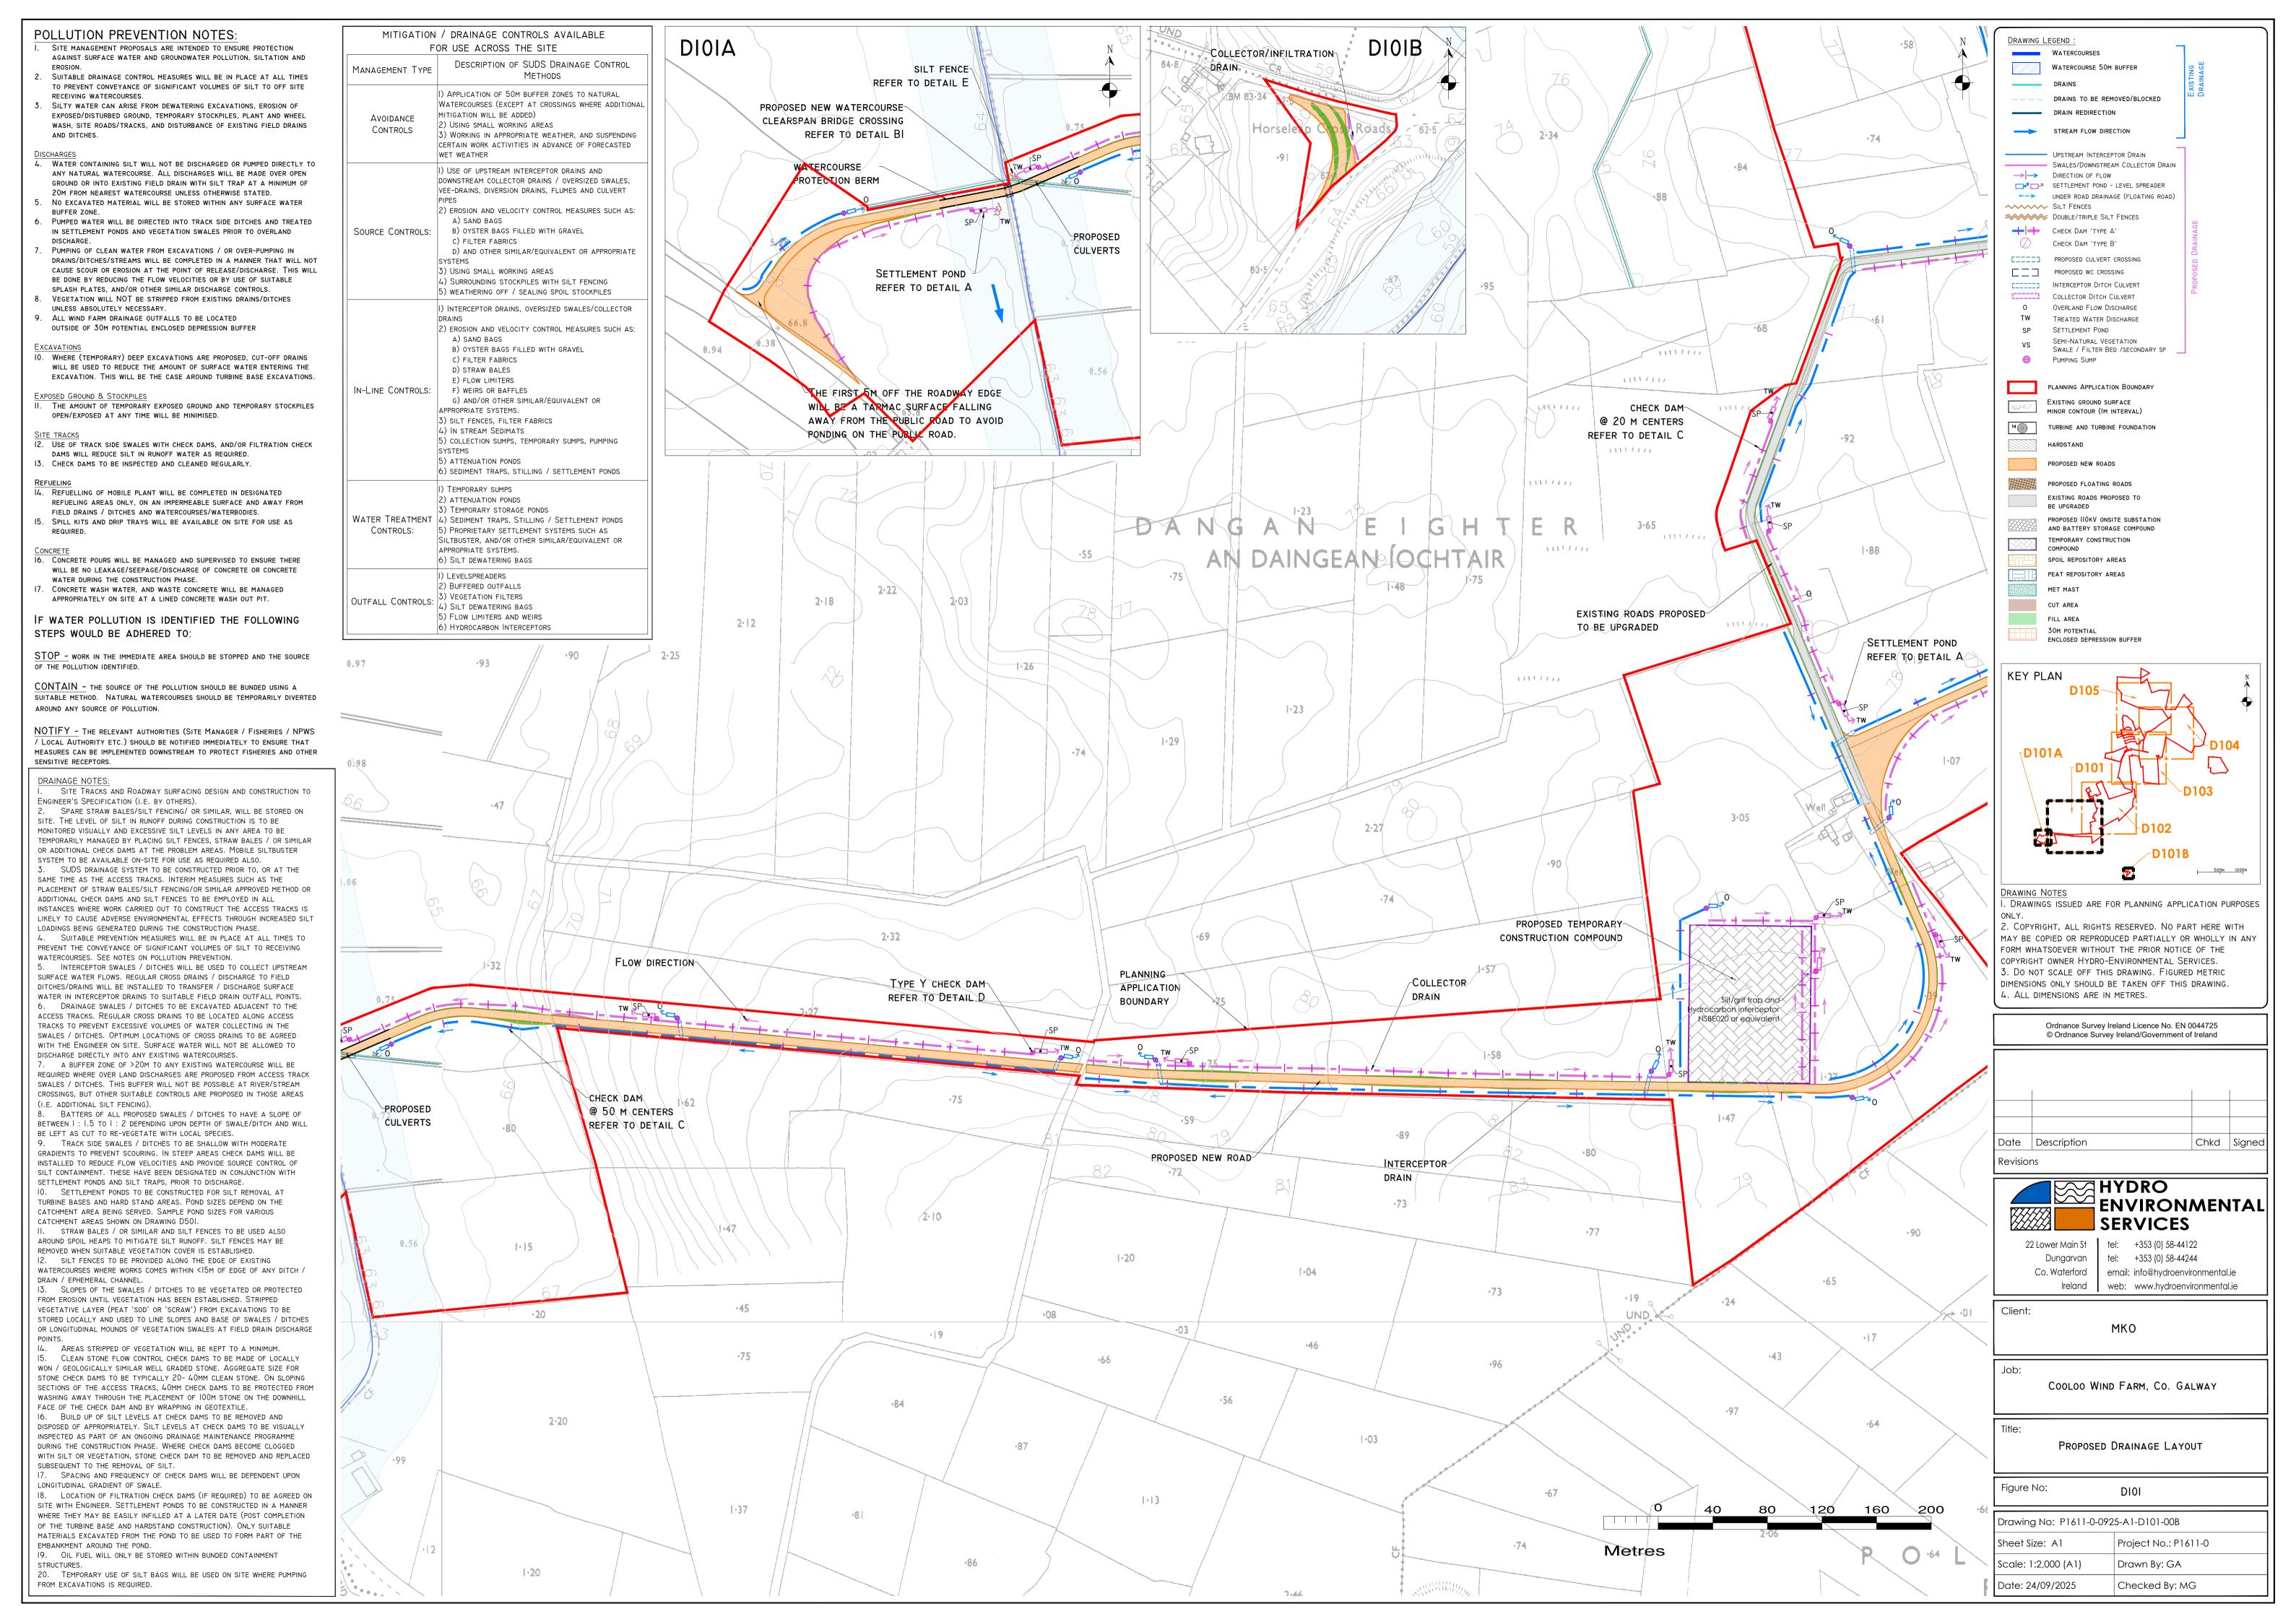

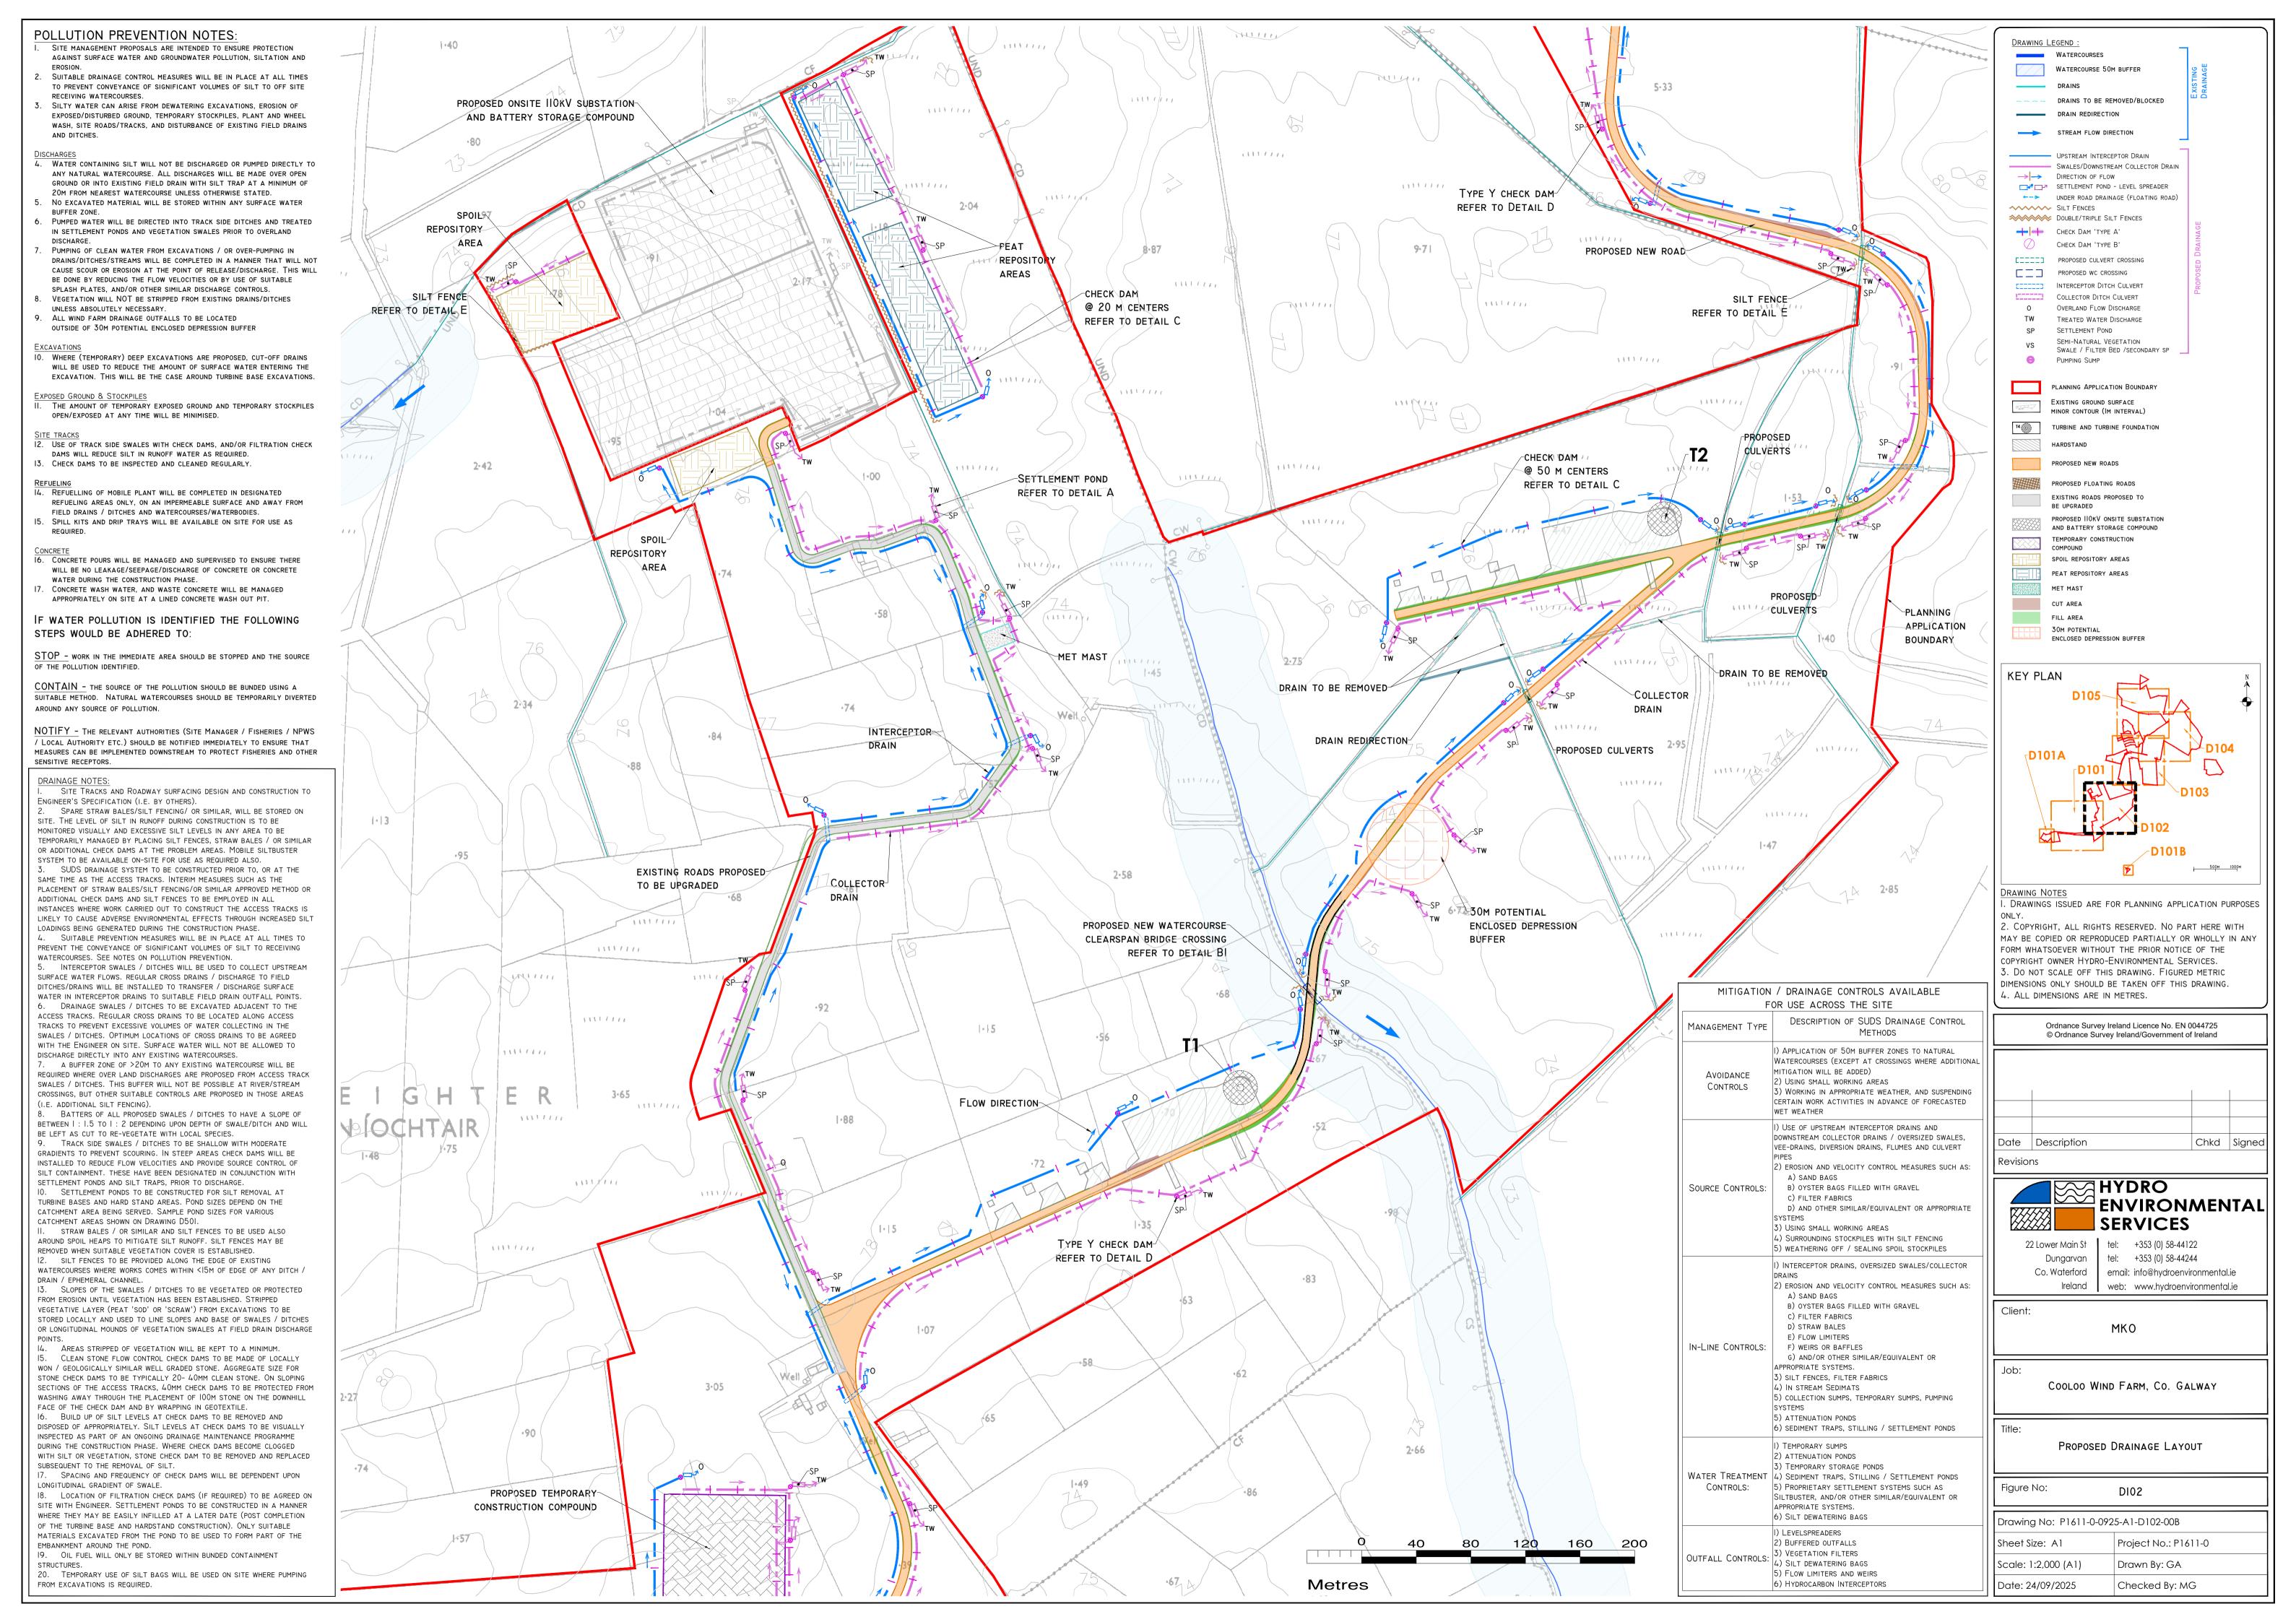

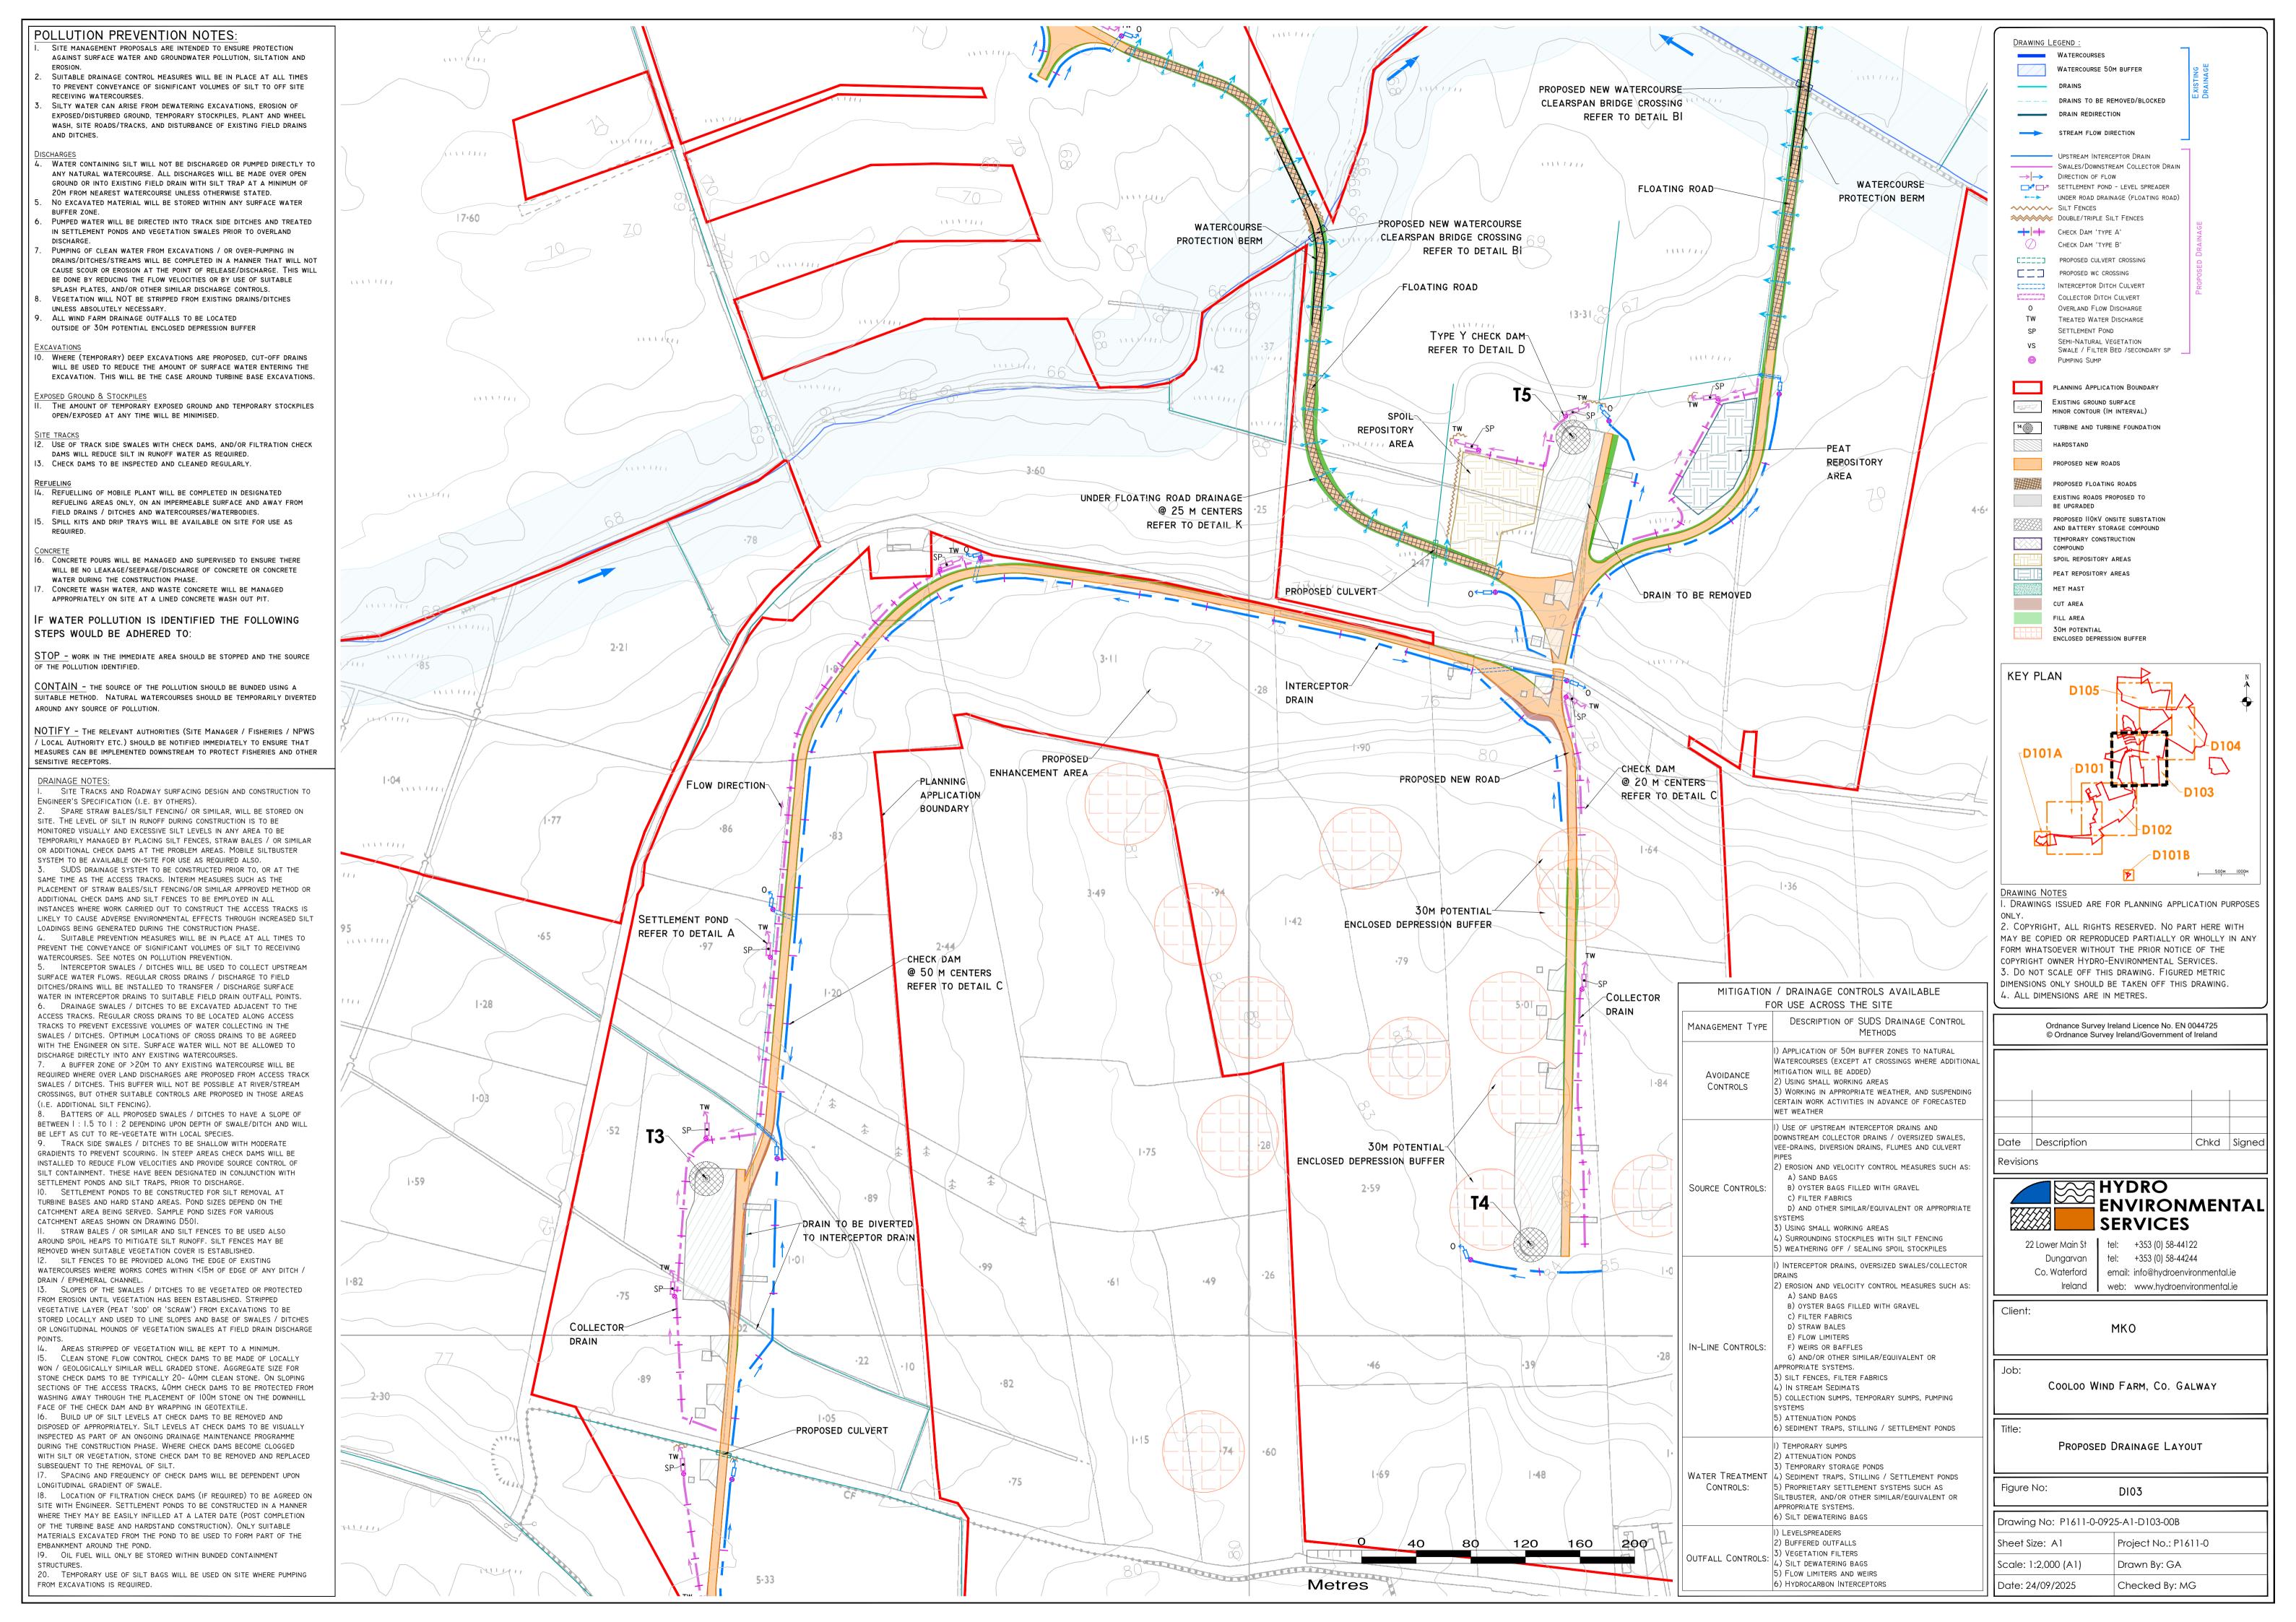


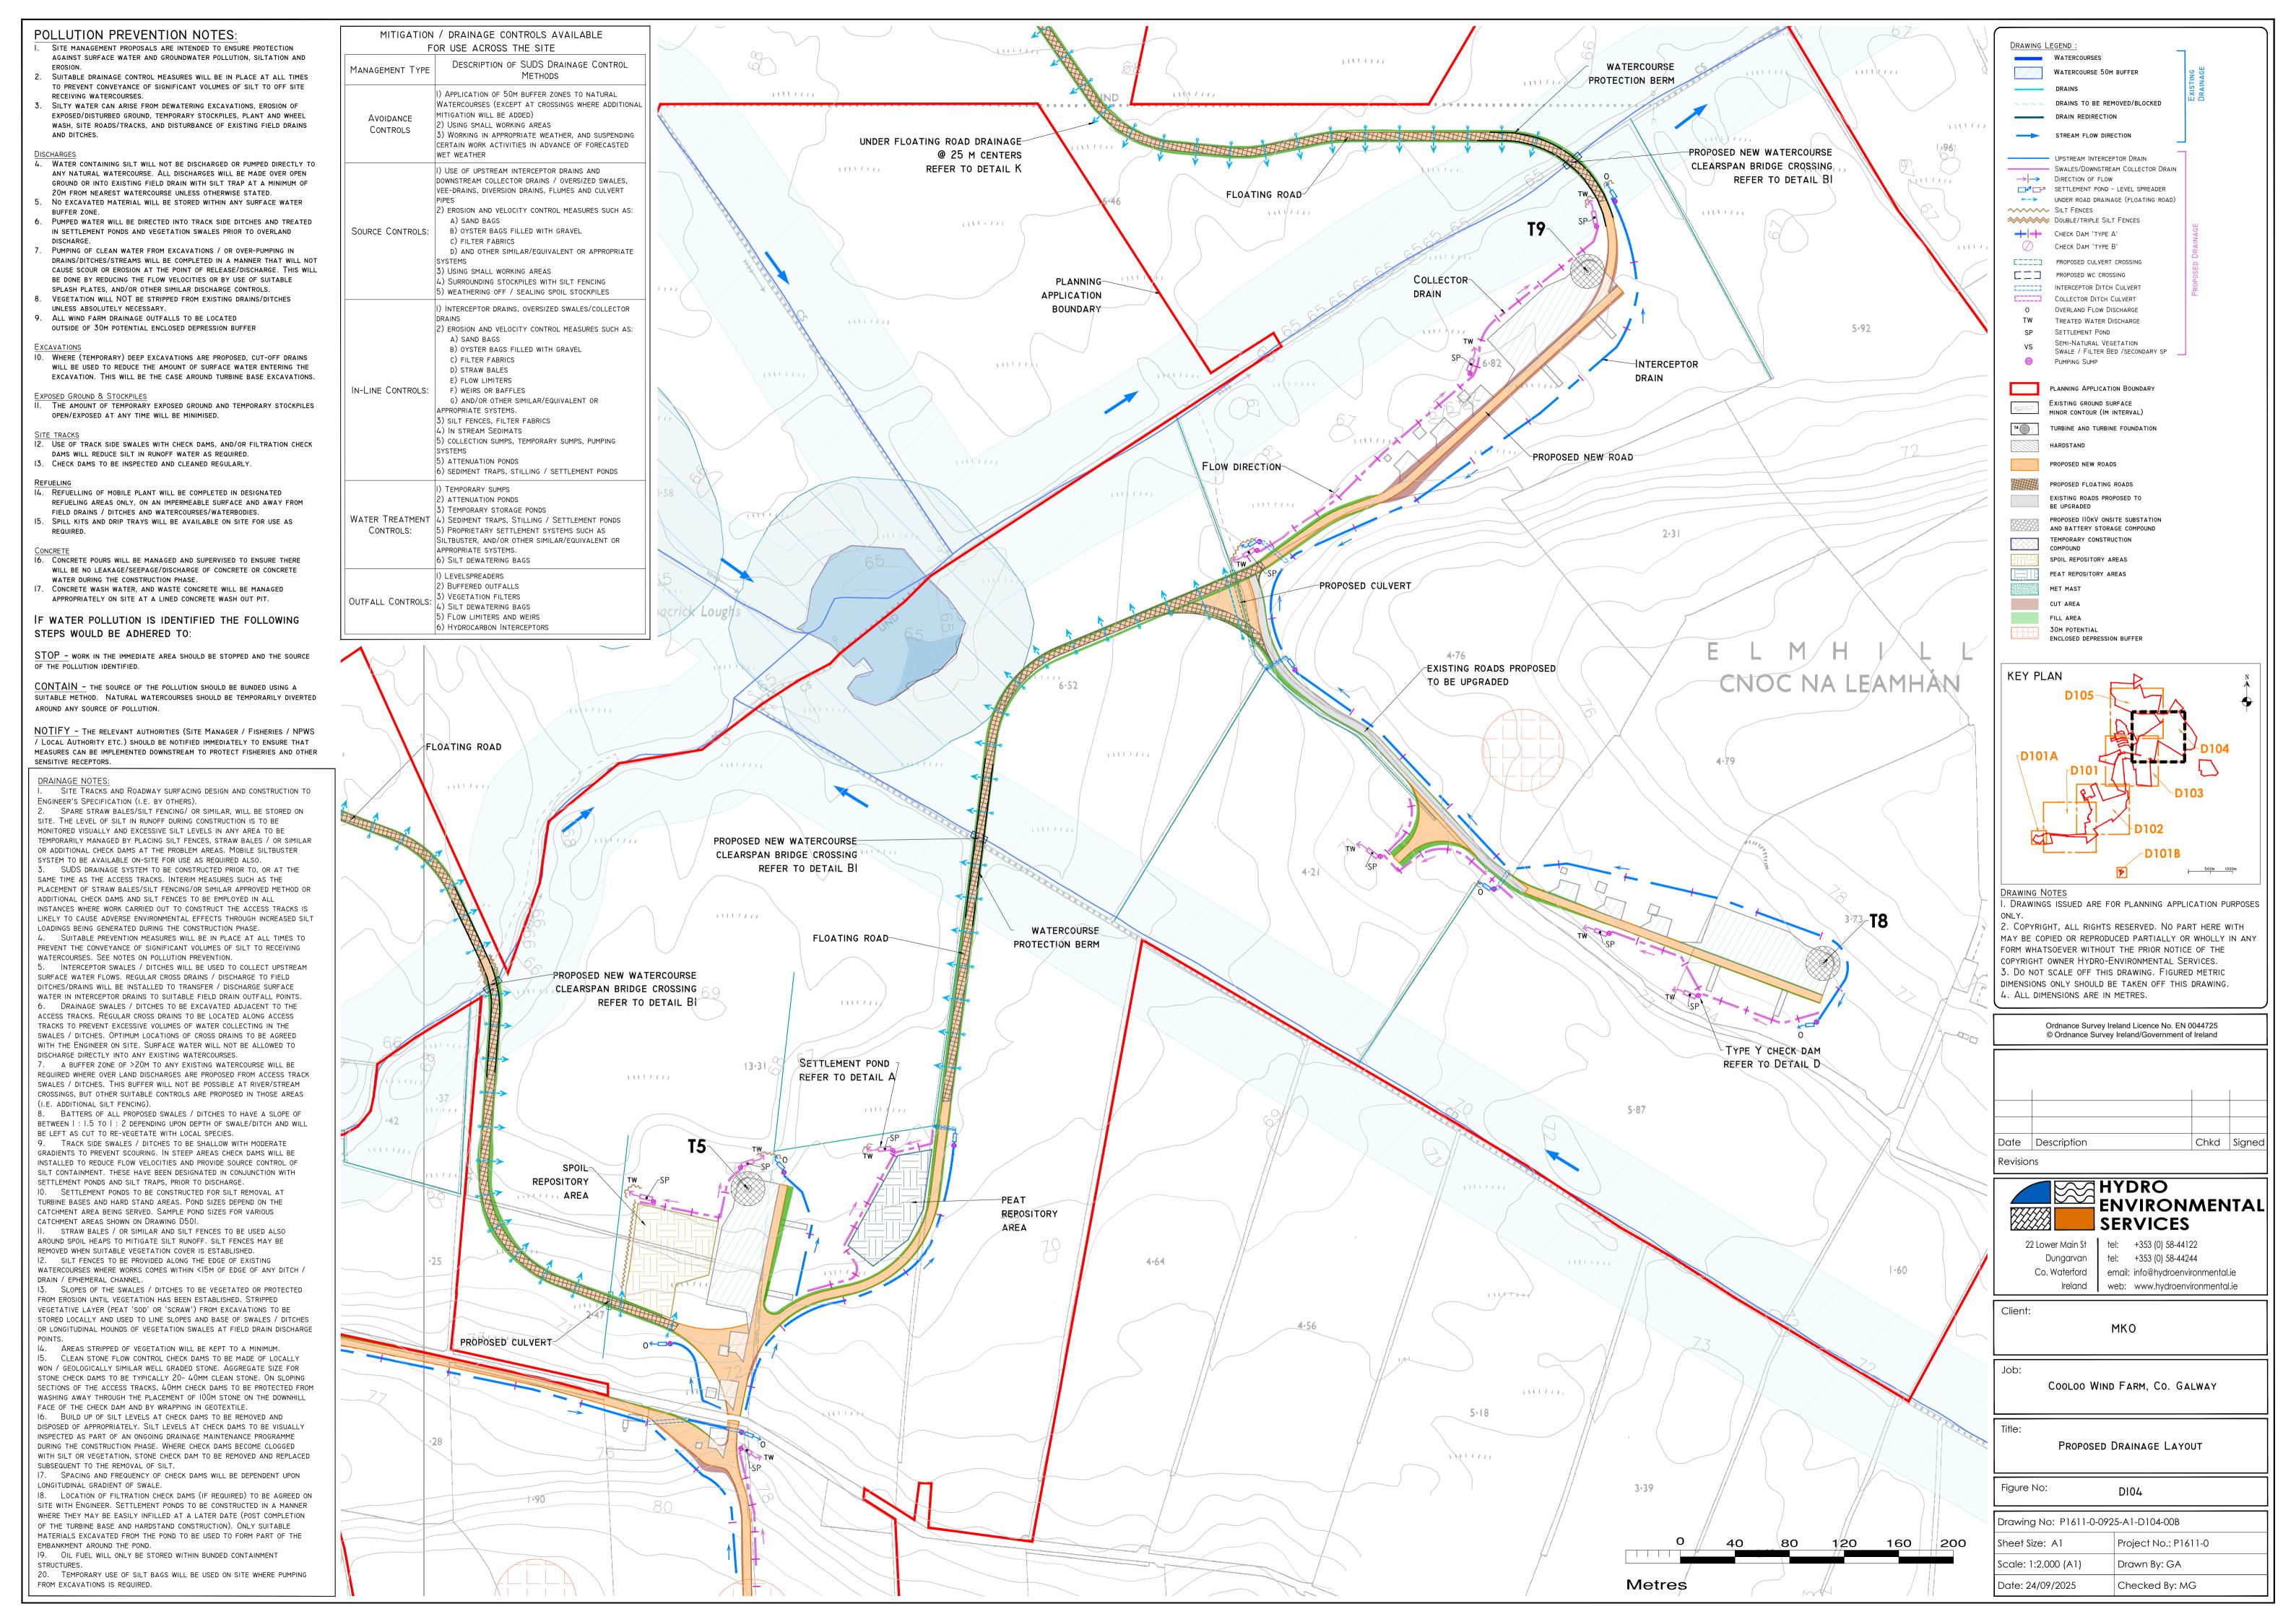

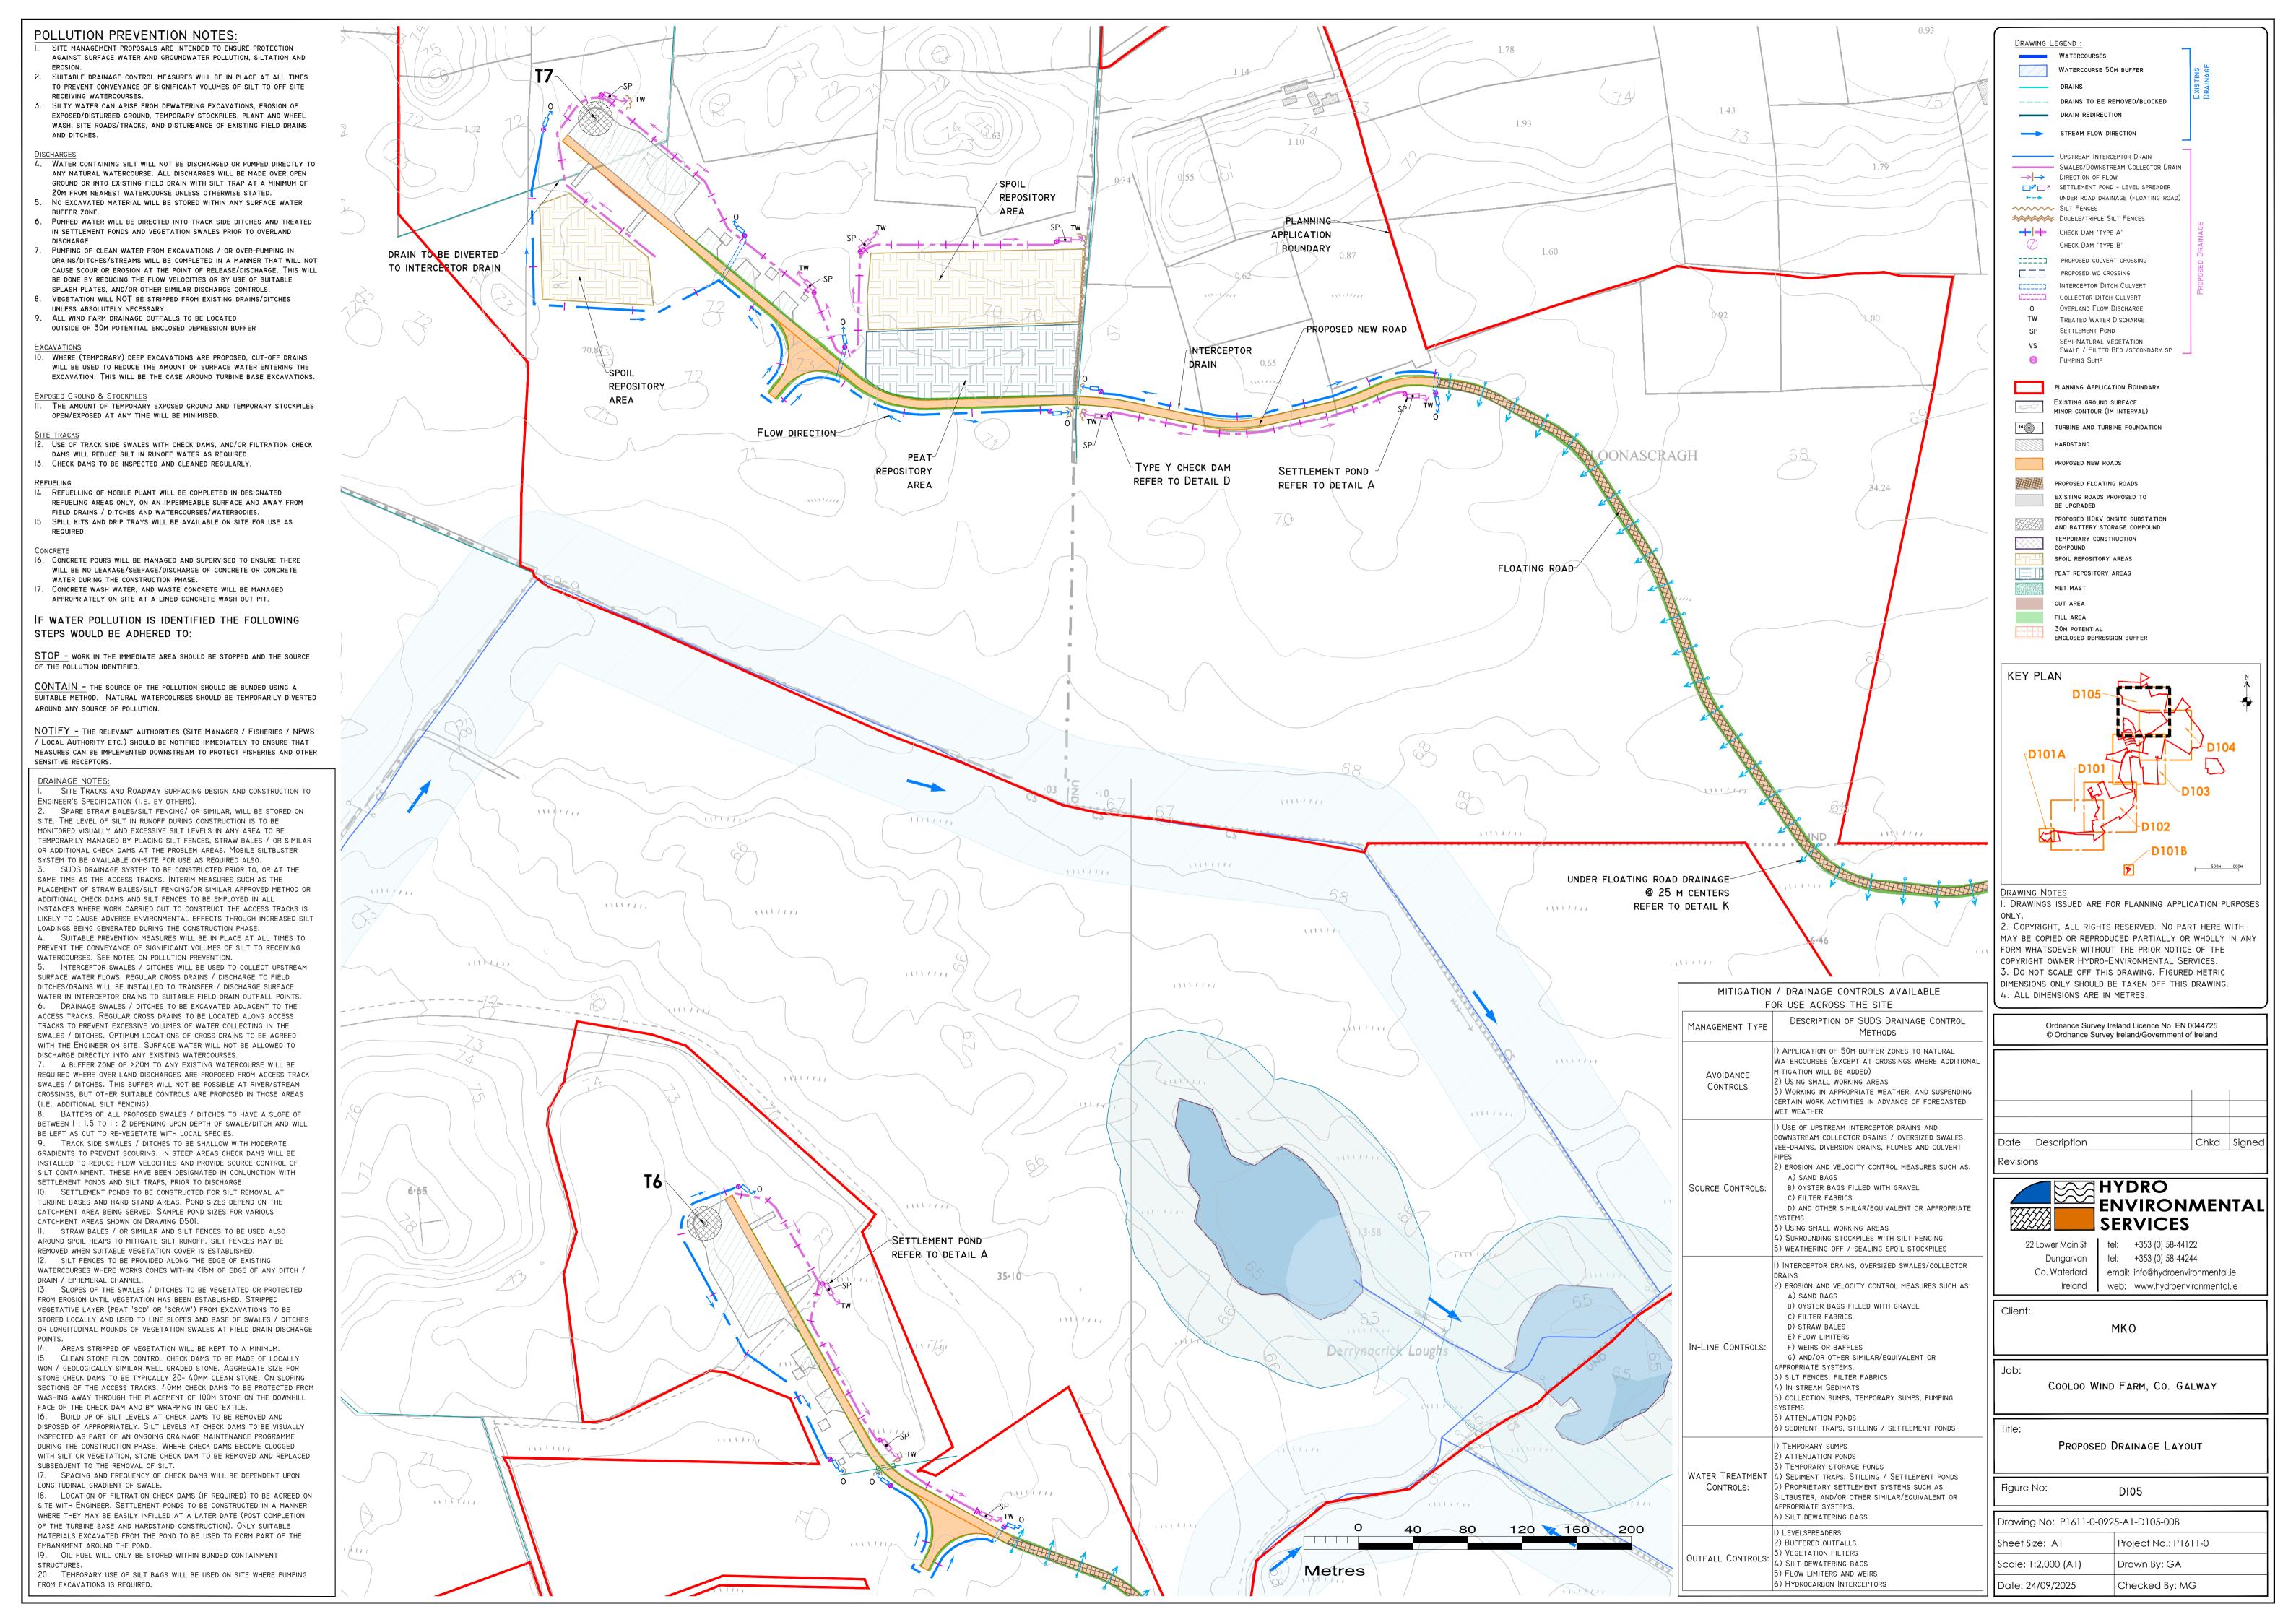


### WINDFARM ACCESS TRACK — COMPACTED CAPPING LAYER 1.75% DRAINAGE GRANULAR DITCH WHERE FILL MATERIAL PEAT/ DRAINAGE REQUIRED CROSS FALL = 5% DITCH WHERE + + + + + + PEAT/SOFT SOIL + + + + + 1 SOFT SOIL REQUIRED + + + + + + + + + + + + GEOTEXTILE SEPARATOR ON FINAL THICKNESS TO BE TILL / WEATHERED ROCK TILL / WEATHERED ROCK TILL/WEATHERED ROCK. NOT DETERMINED AT DETAILED DESIGN REQUIRED ON COMPETENT ROCK

# SECTION THROUGH ACCESS TRACK NEW CONSTRUCTION: FOUNDED - DETAIL 01 SCALE: 1:25

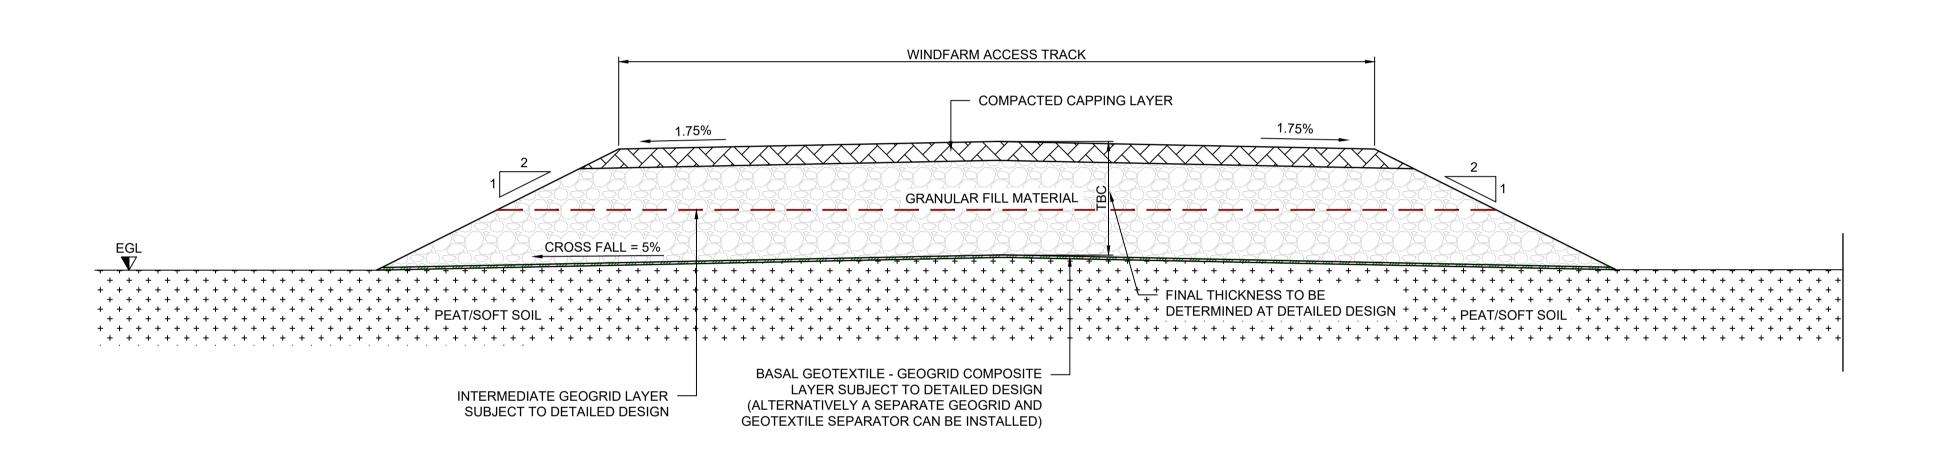

# SECTION THROUGH ACCESS TRACK NEW CONSTRUCTION: FLOATED - DETAIL 02 SCALE: 1:25

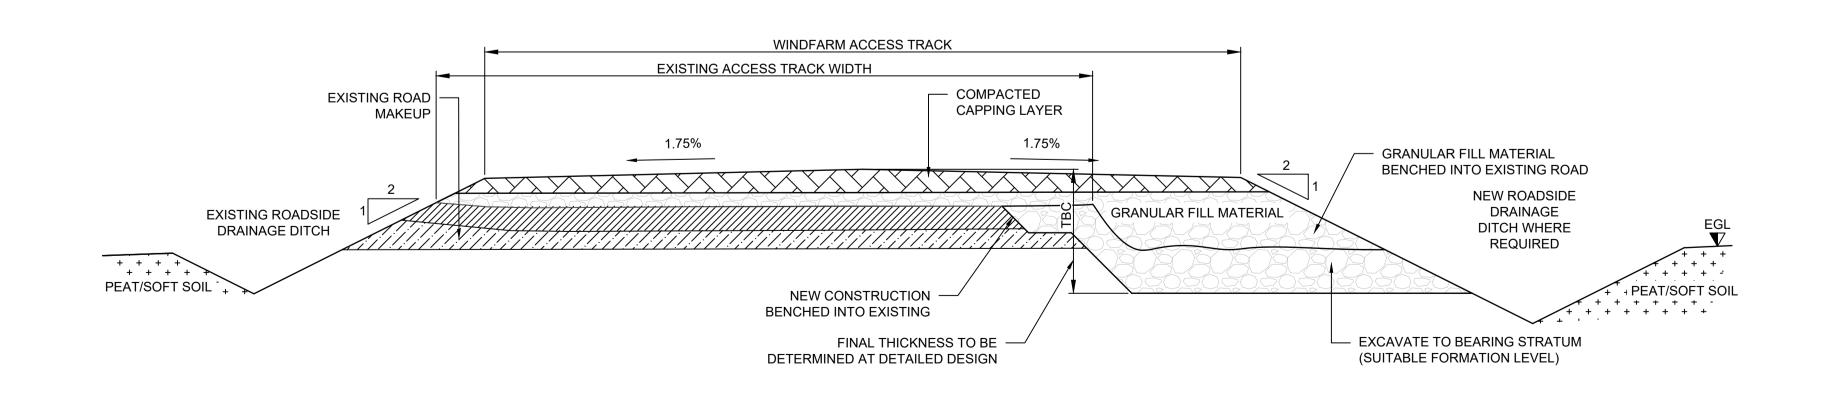

SECTION THROUGH WIDENING OF EXISTING ACCESS TRACK: FOUNDED - DETAIL 03
SCALE: 1:25

### NOTES:

- 1. THIS DRAWING IS FOR PLANNING AND ENVIRONMENTAL IMPACT ASSESSMENT PURPOSES AND SHOULD NOT BE USED AS DETAILED DESIGN OR FOR CONSTRUCTION.
- DO NOT SCALE FROM DRAWINGS.
   THE STRENGTH OF THE SUBFORMATION SOILS TO BE ASSESSED BY A SUITABLY QUALIFIED GEOTECHNICAL ENGINEER PRIOR TO
- CONSTRUCTION / PLACEMENT OF FILL.

  4. DRAINAGE TO BE PROVIDED TO PREVENT WATER DEGRADATION OF THE SUBFORMATION SOILS IN-LINE WITH DRAINAGE STRATEGY.

### HEALTH & SAFETY:

1. NO OPERATIVES TO ACCESS ANY UNSUPPORTED TRENCHES. TRENCHES TO BE ADEQUATELY BATTERED BACK OR SUPPORTED WHERE NECESSARY. SAFE TEMPORARY BATTER ANGLES TO BE ASSESSED IN ACCORDANCE WITH CIRIA REPORT 97 "TRENCHING PRACTICE".

REV: S2-P01 DATE: 29/08/25 DRAWN BY: PF CHECKED BY: DM
DESCRIPTION: ISSUED FOR INFORMATION



Unit A2, Nutgrove Office Park, Rathfarnham, Dublin 14, D14 X627 Ireland. T +353 (0)1-2071000 E info@gdgeo.com

www.gdgeo.com

FOR INFORMATION



PROJECT TITLE:

COOLOO WIND FARM

22098- GDG-ZZ-XX-DR-C-0100

Revision: -S2-P01

DRAWING TITLE:

ACCESS ROAD STANDARD DETAILS

SCALE: 1:25 SHEET SIZE: A1 DATE: 29/08/2025

DRAWN BY: PF CHECKED BY: DM APPROVED BY: TO'S

